
$\triangleright$ 

7084

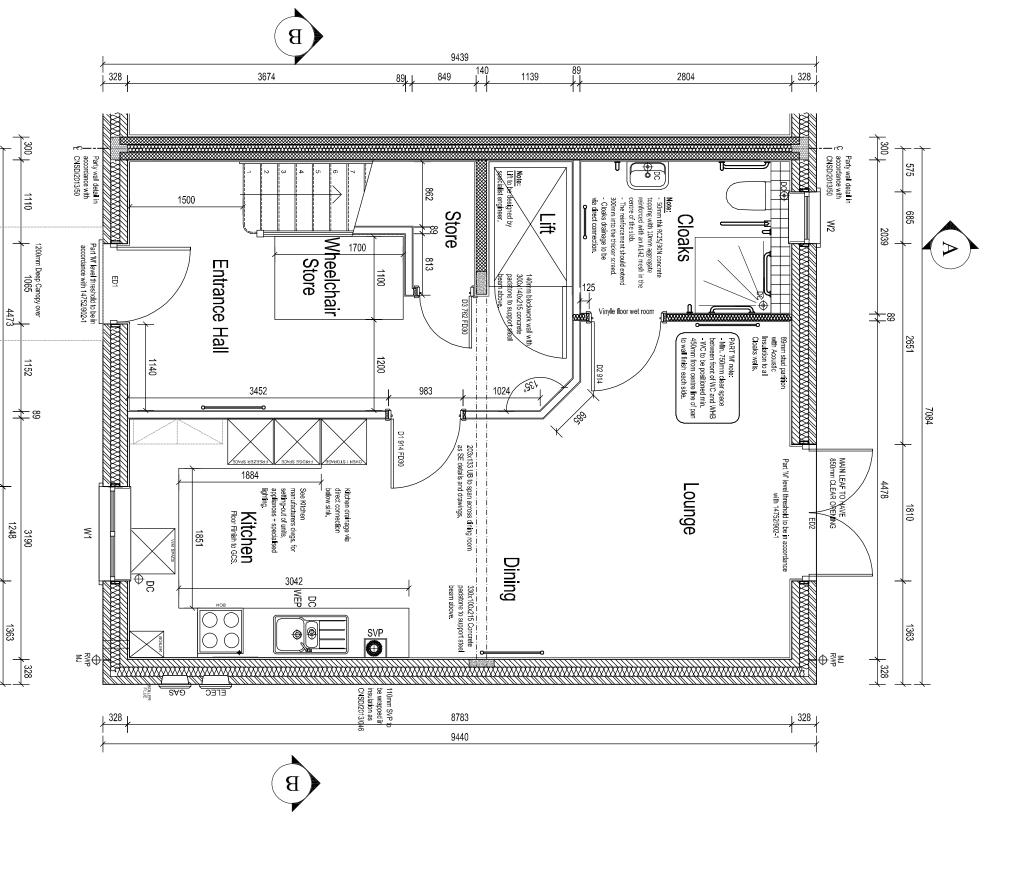

AS 60

BRICK

THIS WORKING DRAWING IS TO BE READ IN CONJUNCTION WITH THE CREST STANDARD CONSTRUCTION NOTES AND THE STANDARD WORKMANSHIP AND MATERIALS SPECIFICATION

## RISK SCHEDULE

## ITEM **DESCRIPTION OF RISK & ACTION**

Risk - Handling of large / heavy flat gauge lintel

Action - A method statement to be provided by supplier and approved prior to commencement on site

WALL CONSTRUCTION LEGEND - 2 Storey

WALT TYPE 1

EXTERNAL CANTY WALL WHERE NDICATED TO CONSIST OF:

EXTERNAL CANTY WALL WHERE NDICATED TO CONSIST OF:

102mm NATURAL STOKE OR FACING SROCK OUTER LEAF IN ACCORDANCE WITH

MATERIAL FINISHES SCHEDULE AND PLOT SPECIFIC UNITS.

122mm CANTY CONTANNOS DUL FILL SPRINGVALE ECOBEAD PLATINUAM INSULATION

(0.0300/m/m)

(0.0300/m/m)

102mm NSILLATION BLOCK (MIN 3.6Mmm² AND 0.15Mm/m ) INMER LEAF

FINISHED WITH 12,5mm PLASTERSOADO ON DASS WITH 3mm PLASTER SKAM PHISH.

ALL REPLALS AND SOFFITS TO BE FINISHED IN ACCORDANCE WITH CIN STANDARD

CONSTRUCTION NOTES 2013.

WALL TYPE 2
PARTY WALL WHERE INDICATED TO CONSIST OF:
2 LEWES OF "00mm" THCX 3.84 LIGHTWEIGHT BLOCKWORK (800 - 800 (q/m²))
-100mm CAWITY FULLY FILLED WITH SANVI-COBAN 100mm ISOVER RD PARTY WALL
ROLL
-EACH SOE TO BE FINISHED WITH 12.5mm PLASTERBOARD ON DABS (MIN 8/g/m²) JAND
3mm PLASTER SOM FINISH
TO BE IN STRICT ACCORDANCE WITH ROBUST STANDARD DETAIL E-VIM-24

INTERNAL NON LOADBEARING PARTITION WHERE INDICATED ON PLAN TO BE 38 x 86mm TIMBER STUDS AT MAX 690mm CIRS OR AS OTHERWISE INDICATED ON DEAWNING, WITH 12.5mm PLASTERGOARD EACH SIDE AND 3mm PLASTER SKIM FILESH, PROVIDE REINFORCEMENT IN ACCORDANCE WITH CIN STANDARD CONSTRUCTION NOTES 2013

INTERNAL NON LOADBEARING PARTITION WHERE INDICATED ON PLAN TO BE 38 x 1/40mm TIMBERS STUDS AT MAX 800mm CTRS OR AS OTHERWISE INDICATED ON 1/40mm TIMBERS WITH 1.25mm PLASTERBOARD ON DASS EACH SIDE AND 3mm PLASTER SKIM FINSH, PROUNDE REINFORCHENT IN ACCORDANCE WITH CAN STANDARD CONSTRUCTION NOTES 2013

INTERNAL LOADBEARING PARTITION WHERE INDI 3.6N AIRCRETE BLOCK AND FINISHED WITH 12.5n WITH 3mm PLASTER SKIM FINISH TO EACH SIDE. ARTITION WHERE INDICATED ON PLAN TO BE 140mm D FINISHED WITH 12.5mm PLASTERBOARD ON DABS

MTERWAL NON LOADSEARING PARTITION WHERE NOTICATED ON PLAN SEPARATING STRUCTURES BETWEEN ALL WC COMPARTMENTS AND HABITABLE ROOMS TO BE 39 \*\*2.5 Sharm THABLE ROOMS TO WAS SOFTEN CHES ON AS OTHERWISE MOTICATED ON DEAMINGS. WITH LZCAMP LASSTEROMORP AS OF 100 MET PAISTEROMORP AS OT 100 MET PAIST

NITERNAL NON LOADSEARING PARTITION WHERE NOICHTED ON PLAN TO BE 38 X 88mm TIMERE STUDS AT IMAX 30mm CITRS TO ALL SIZES OF SHOWER CUBICLES AND 80mm CITS LESCHEERE, WITH LAZEMAND TO MONETINE ELESCHEERE, WITH LAZEMAND TO ALL WIET ROOMS (STANDARD 1/20mm TO HOME WET ROOMS (STANDARD 1/20mm TO HOME WET ROOMS (STANDARD 1/20mm TO HOME WET ROOMS (STANDARD CONSTRUCTION NOTES 2013)

TO BE READ IN CONJUNCTION WITH CREST NICHOLSON STANDARD CONSTRUCTION NOTES 2013 MJ and RWP: In all situations where this house type forms part of a terrace, refer to the Block Plans for confirmation of movement joint and rainwater gipe positions

ADDITIONAL NOTE ADDED TO CLOAK ROOM
CLOAK ROOM LAYOUT UPDATED TO CN COMMENTS
CONSTRUCTIONISSUE
LOBBY FORMED TO PROVIDE PROTECTED ESCAPE
TENDER ISSUE
ADJUSTED LIFT WALL IN LINE WITH BDC COMMENTS
GROUNDWORKS ISSUE

R77234288

Status:

	CO
	ITSI
_	200
	TIO
	Z

Relay Point Wilnecote Tamworth B77 5PA Crest Nicholson Ltd.
Pacific House

Site:	m	In: Size:	
Site:	BODICOTE		
House Type:	AH2B WC	Unit Size:114 m <sup>2</sup> 1227 ft <sup>2</sup>	m² 1227
Drg Title:	GROUND FLOOR PLAN	Z	
Scale:	1.50	Page Size: A.3   Date:NAD 10	Date: N / A D

Crest

www.crestnicholson.com

Revision: )2 C3	3F-A-1002	Drawing No: 14752-HMA-AH2BWC-GF-A-1002
Checked: DL	Drawn: OR	-
MAR 19	Page Size: A3	Scale: 1:50