

#### LANDSCAPE SPECIFICATION

##### SITE PREPARATION

Excavation topsoil shall be stripped before building works begin. Imported topsoil shall be to BS3862: 2007 Specification for Topsoil and Requirements for Use. Topsoil shall be multi-purpose grade, of medium texture, with a high proportion of fertile loamy material. It shall be free from subsoil, rubbish, rubble, contamination, roots of perennial weeds and other materials injurious to plant growth. The maximum stone content of the soil shall be 20%, with the maximum size of stone 25mm in any one dimension. All topsoil shall be stacked in heaps, not exceeding 2m high. During storage, topsoil heaps shall be kept free from compaction, contamination and weeds.

**Excavation**  
Excavation shall NOT be undertaken within the root protection area of any existing trees or shrubs to be retained. Unless otherwise indicated areas to be planted / seeded shall be cleared of all surface rubbish and excavated to the dimensions below finished level as follows, when the soil is not waterlogged or frozen. Ensure the location of all services is known before any excavation operations.

**Tree pits:** As per detail  
**Shrub and hedge pit / trench:** 450mm deep  
**Grass areas:** 300mm deep  
**Wildflower grassland areas:** Excavate to finished levels

The base of excavated areas shall be forked or otherwise cultivated to a depth of 150mm to facilitate drainage and all bricks, stones and other debris, etc. over 75mm in any one dimension shall be removed. Similarly, areas trafficked by construction vehicles shall be raked to a depth of 150-300mm to relieve compaction.

**Backfilling with Subsoil**  
Where excavated areas are lower than the required depths, excavations shall be backfilled with selected subsoil and lightly consolidated to make up levels. Selected subsoil shall be friable, second quality topsoil or similar and free of rubbish, roots, stones over 75mm in any one dimension, perennial weeds or other materials injurious to plant growth.

**Backfilling with Topsoil**  
Trees, shrub and hedge pit / trench excavations shall be backfilled, in layers, with clean topsoil (as specified above) thoroughly mixed with planting compost e.g. 'Melcourt Topgrow' compost at a rate of 20 litres/m<sup>3</sup>. An approved tree and shrub fertilizer shall be added to topsoil, prior to backfilling tree-pits. Grass areas (excluding wildflower grassland areas) shall be backfilled with topsoil in layers of 150mm depth.

**Cultivation**  
Prior to cultivation if planting / seeding areas are weed infested, weed growth to be strimmed, the arisings removed and re-growth treated with an approved herbicide ie Glyphosate. Treatment to be undertaken in the growing season preceding planting, at a minimum 4 weeks prior to works to allow for repeat treatment if necessary.

**Cultivation**  
Cultivation shall not be undertaken within the root protection area of any trees / shrubs to be retained, without prior agreement from the Local Planning Authority. Topsoil shall be cultivated by hand or machine to a depth of 150mm, with minimal compaction by machine. Cultivate to the following depths and till, removing all rubbish, vegetation, perennial weeds, roots, stones over 25mm in any one dimension and rake to even levels.

**Planting areas:** 300mm deep cultivation to medium till  
**Grass seeding areas:** 150mm deep cultivation to fine till raked to a smooth evenly firmed bed  
**Turf areas:** 150mm deep cultivation to medium till raked to a smooth evenly firmed bed  
**Wildflower grassland areas:** 150mm deep cultivation to medium till raked to a smooth evenly firmed bed

**Wildflower grassland areas:** Where un-excavated areas are to be seeded with wildflower grassland mix the topsoil shall be cultivated to turn the soil over to a depth of 300mm to bring subsoil to the surface. Elsewhere, excavated areas to be seeded with wildflower grassland mix to be backfilled to finished levels with subsoil (as above).

**PLANTING**  
Plant Species and Timing  
Plant material and operations shall conform to BS8545 - 2014, BS 3936 Nursery Stock (Parts 1-10), BS 4428 : 1989, BS 4043 : 1989 and BS 5837 - 2012. The planting season shall be from the 1st October to the 31st March. Container grown stock may be planted outside this season if accompanied by daily watering, or as necessary to ensure healthy establishment. Planting shall not be carried out during periods of frost, drought, cold dry winds or when the soil is waterlogged or frozen.

**Planting**  
All planting that is within the root protection area of existing trees/shrubs to be retained, shall be undertaken by hand and positions altered should tree roots be encountered, in order to avoid damage to the root system.

All plants shall be set out evenly over the areas as indicated, to the density and quantities shown. All plants shall be planted upright at the same depth as the nursery soil level and evenly spaced, leaving room for growth. All restrictive containers shall be removed with roots not twisted. Immediately following planting, all plants shall be watered-in to field capacity.

Container grown and root balled plants shall be planted in a planting pit sufficient to accommodate the plant without causing root damage, with a minimum 50mm backfill beyond the root ball extent. Plants to be firmed, watered-in and dead, damaged or lopsided branches shall be removed after planting. Bare-root plants shall be slit planted, incorporating an approved high phosphate, slow-release fertilizer.

**Tree Planting and Support**  
Tree planted in landscape areas shall be installed as specified.

All trees to be firmed in after planting. All trees shall have irrigation / aeration system units fitted to fully surround the root ball.

**Hedge Planting**  
Hedges shall be planted in a single row as per detail. Dead, damaged or straggly branches shall be removed after planting. All transplants in hedge and native mixes shall be fitted with individual protection ie shrub shelters, spiral guards as specified, or alternatively the planting areas shall be protected with rabbit-proof fencing. All shrub shelters / spiral guards shall be black or green, adequately supported and installed to allow for expansion.

**Mulching**  
Prior to the application of mulch the planting areas shall be completely weed free and watered sufficiently to achieve field capacity. The surface of the planting areas shall be mulched with a minimum 75mm depth layer of 15-65mm nominal particle size, dark, matured woodchip mulch, ensuring that the low branches of trees, shrubs and/or herbaceous plants are NOT smothered.

Mulch shall be an approved product and completely weed and weed seed free. The mulch shall be topped up to maintain, after settlement, a depth of not less than 50mm. Trees in grass areas shall be planted centrally within a 1m diameter mulch bed, to be mulched to 75mm deep. The surface of mulch to be 10mm below the surface of adjacent lawn / hard surface.

#### GRASS AREAS

**Turf**  
Turf shall accord with BS 3969: 1998. It shall be good quality meadow / cultivated, amenity turf free from weeds and be laid on even, prepared ground (as detailed above), during periods of suitable warm and moist weather conditions. Pre-turf fertiliser shall be applied to manufacturer's recommendations and turf shall be laid in accordance with BS 4428: 1989.

Turf shall be laid with broken joints well-butted up, working from timber planks to avoid damaging turf when laying. Water as necessary to avoid shrinkage and achieve satisfactory establishment. Undertake good horticultural practice to ensure establishment of a healthy grass sward.

**Grass Seeding**  
Areas of amenity grass shall be seeded with a general amenity grass mix as specified during the period March to May or September to October, during periods of moist, warm weather conditions without significant wind. Pre-seeding fertiliser shall be applied to manufacturer's recommendations. Seed shall be sown on even, prepared ground (as detailed above), at a rate of 35g/m<sup>2</sup> or as specified, in two transverse operations. Lightly roll seed bed after sowing. Water as necessary to avoid shrinkage and achieve satisfactory establishment. Undertake good horticultural practice to ensure establishment of a healthy grass sward.

**Wildflower Grassland Seeding**  
Areas of wildflower grassland shall be seeded with a wildflower grassland mix suitable for the soil type as specified, during the period March to May or September to October, during periods of suitable warm and moist weather conditions. Pre-seeding fertiliser shall be applied to manufacturer's recommendations. Seed shall be sown on prepared ground (as detailed above), at a rate of 5g/m<sup>2</sup> or as specified. Lightly roll seed bed after sowing. Water as necessary to avoid shrinkage and achieve satisfactory establishment. Undertake good horticultural practice to ensure establishment of a healthy wildflower grass sward.

**AFTERCARE PERIOD**  
Regular Visits  
During the specified Aftercare Period maintenance visits shall be carried out, at least monthly from April to September and twice during the dormant season to carry out the following operations to establish healthy growing plants / grass in weed free areas: watering, firming-up, removal of litter, pest and disease control, general pruning, checking guards, ties and stakes, weed control, grass cutting and autumn tidyng. All arisings shall be carted away and the site shall be left clean and tidy at all times.

**Watering**  
All planting and grass areas shall not be allowed to dry out and shall be kept well watered during the growing season, ensuring the soil is kept moist at all times but avoiding waterlogging.

**Replacement Planting**  
During each August within the Aftercare Period an inspection shall be made and all plants that have died, are missing, damaged or have failed to thrive, shall be noted and replaced in the following planting season.




**Grass Cutting**  
During the first and subsequent growing seasons amenity grass shall be kept at a height of 25mm to 50mm. Any bare patches are to be resown. Selective weed control shall be undertaken as necessary once the sward is sufficiently established.

**Wildflower Grassland Cutting**  
During the first growing season cut wildflower grassland every 2 months to a height of 50mm and in subsequent growing seasons cut to 50mm height during late March and late August / early September or as specified. All arisings shall be collected and removed from the site to avoid smothering the sward and to reduce nutrient levels. Spot treat perennial weeds with Glyphosate at the manufacturer's recommended dose rate / or hand pull.

**PLANTING SPECIFICATIONS**

**CONTAINER GROWN TREE PLANTING**  
Container grown tree. Double stake fixing in soft landscape adjacent to Carriageway/footway- Not to scale

To be used in planting of trees with specified Up to 16-18 girth

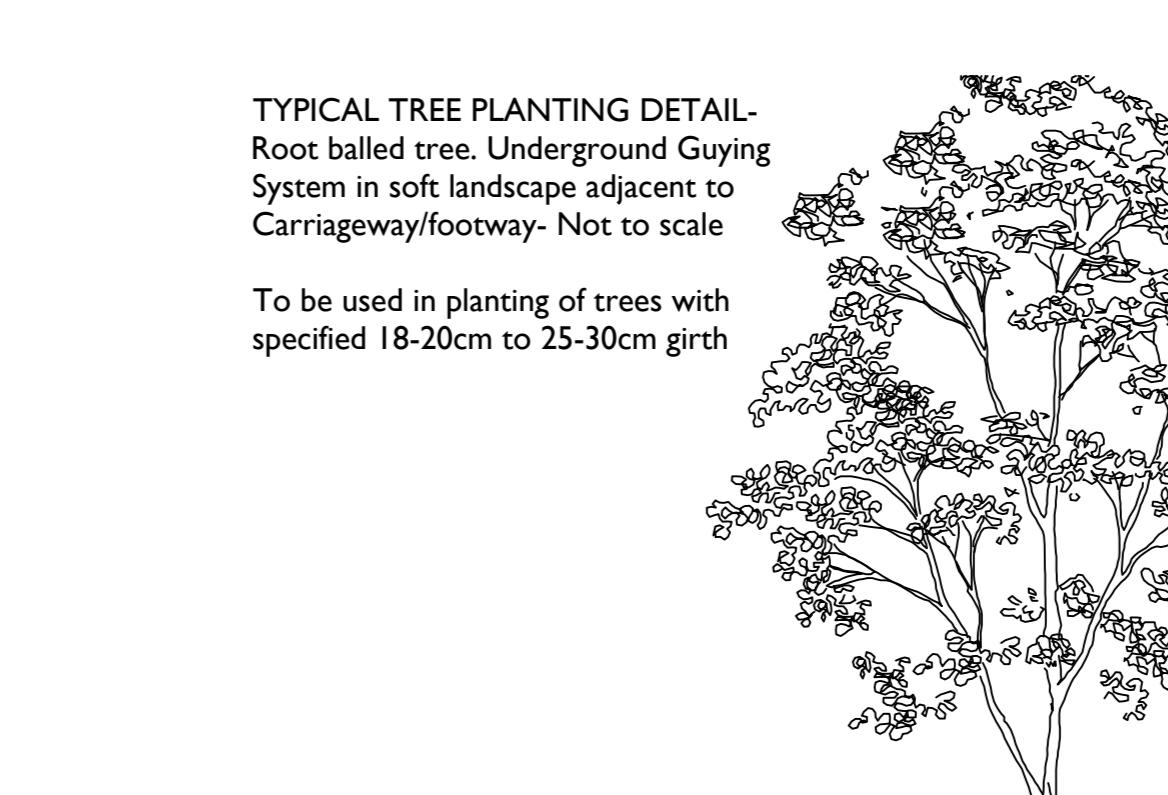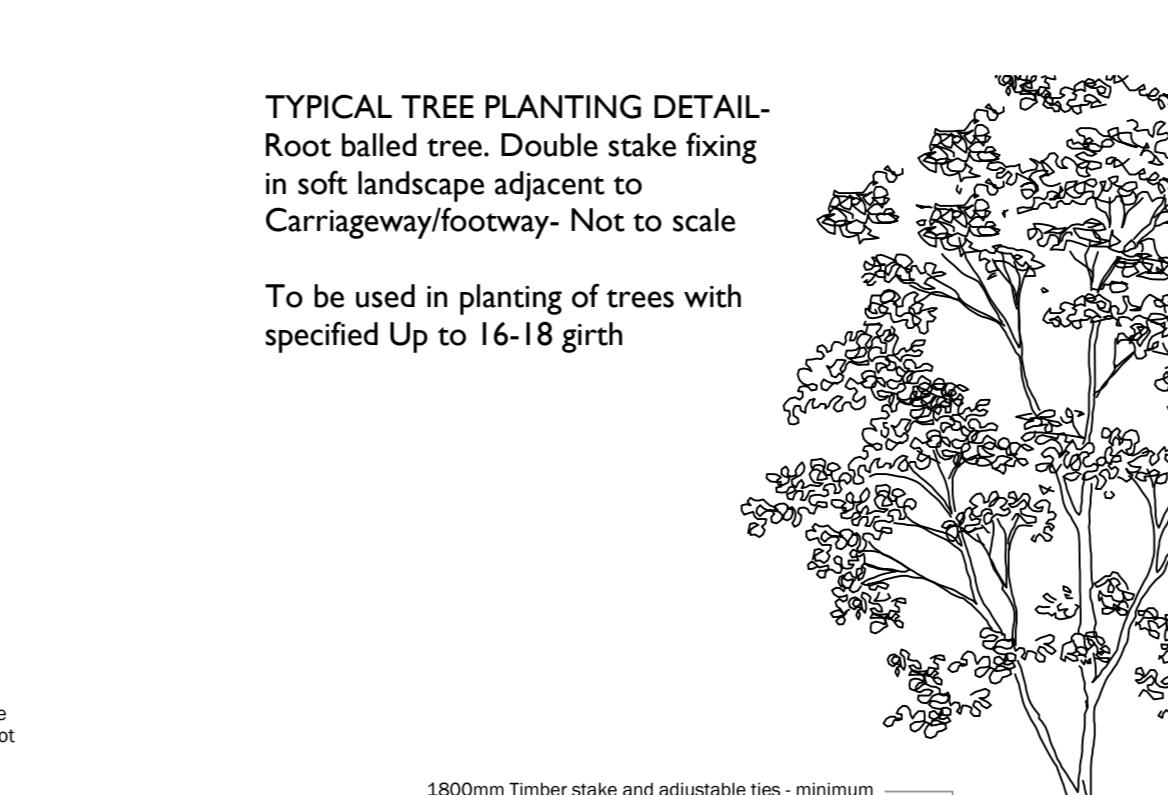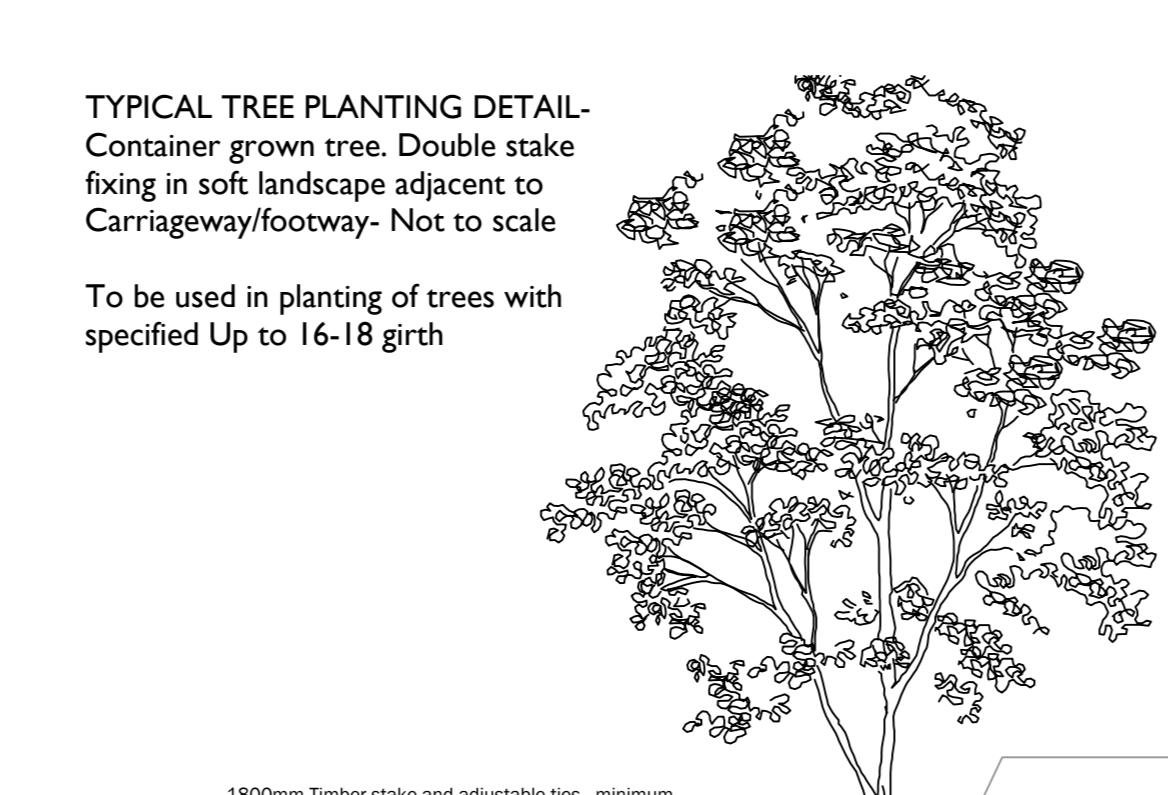

**RRURB1A Rootball Urban irrigation system by GreenBlue Urban or similar approved.**  
Ensure inlet is set to ground level and that system is completely level  
Topsoil to BS-3862-2015 mixed with soil amended with 75mm bark mulch. Trees in grass areas shall be planted centrally within a 1m diameter mulch bed  
Topsoil to BS-3862-2015 mixed with soil amended with 75mm bark mulch. Trees in grass areas shall be planted centrally within a 1m diameter mulch bed  
Carriageway / footway in accordance with Engineer's details / existing planting  
RRURB1A Rootball Urban irrigation system by GreenBlue Urban or similar approved.  
Bottom 350mm of backfilling with good quality topsoil or similar. Topsoil to BS-3862-2015 mixed with soil amended with 75mm bark mulch. Located only to sides of pit and positioned to give the tree as much room as possible to retain soil structure  
Existing subsoil. Not to be compacted where it can be avoided  
Base of tree pit to be 650mm depth (minimum 600mm depth for tree roots). Base of tree pit to be domed with highest point at the centre as shown

**RRURB1A Rootball Urban irrigation system by GreenBlue Urban or similar approved.**  
Ensure inlet is set to ground level and that system is completely level  
Topsoil to BS-3862-2015 mixed with soil amended with 75mm bark mulch. Trees in grass areas shall be planted centrally within a 1m diameter mulch bed  
Carriageway / footway in accordance with Engineer's details / existing planting  
RRURB1A Rootball Urban irrigation system by GreenBlue Urban or similar approved.  
Bottom 350mm of backfilling with good quality topsoil or similar. Topsoil to BS-3862-2015 mixed with soil amended with 75mm bark mulch. Located only to sides of pit and positioned to give the tree as much room as possible to retain soil structure  
Existing subsoil. Not to be compacted where it can be avoided  
Base of tree pit to be 650mm depth (minimum 600mm depth for tree roots). Base of tree pit to be domed with highest point at the centre as shown



Rev	Date	Description
A	11.11.16	Tree No. reduced following comments/ Tree species updated
B	15.01.18	Site layout altered, proposals following architectural layout amendments
C	30.04.18	Post number amendments
D	07.09.18	Planting amendments following architectural layout amendments. Hedge detail revised
E	15.04.19	Site layout altered, proposals adjusted to coordinate

Title: Project Name: Site Plan Drawing No: Date: October 2018 Drawing Type: Landscaping Scale: 1:2000 to A0 Drawing No: 1619 46 1 E

Comments: This drawing is a copy of the original and may be used for any other purpose than the original drawing. It is not to be used for construction purposes.

Reproduced from Original Drawing by [Redacted] on [Redacted]

Copyright © [Redacted] 2018

Contractor: [Redacted]

Architect: [Redacted]

Design: [Redacted]

Planning: [Redacted]

Building: [Redacted]

Structural: [Redacted]

Electrical: [Redacted]

Mechanical: [Redacted]

Plumbing: [Redacted]

Landscaping: [Redacted]

Architectural: [Redacted]

Structural: [Redacted]

Electrical: [Redacted]

Mechanical: [Redacted]

Plumbing: [Redacted]

Landscaping: [Redacted]

Architectural: [Redacted]

Structural: [Redacted]

Electrical: [Redacted]

Mechanical: [Redacted]

Plumbing: [Redacted]

Landscaping: [Redacted]

Architectural: [Redacted]

Structural: [Redacted]

Electrical: [Redacted]

Mechanical: [Redacted]

Plumbing: [Redacted]

Landscaping: [Redacted]

Architectural: [Redacted]

Structural: [Redacted]

Electrical: [Redacted]

Mechanical: [Redacted]

Plumbing: [Redacted]

Landscaping: [Redacted]

Architectural: [Redacted]

Structural: [Redacted]

Electrical: [Redacted]

Mechanical: [Redacted]

Plumbing: [Redacted]

Landscaping: [Redacted]

Architectural: [Redacted]

Structural: [Redacted]

Electrical: [Redacted]

Mechanical: [Redacted]

Plumbing: [Redacted]

Landscaping: [Redacted]

Architectural: [Redacted]

Structural: [Redacted]

Electrical: [Redacted]

Mechanical: [Redacted]

Plumbing: [Redacted]

Landscaping: [Redacted]

Architectural: [Redacted]