



1:500 @ A1  
0m 12.5m 25.0m  
Scale bar @ 1:500

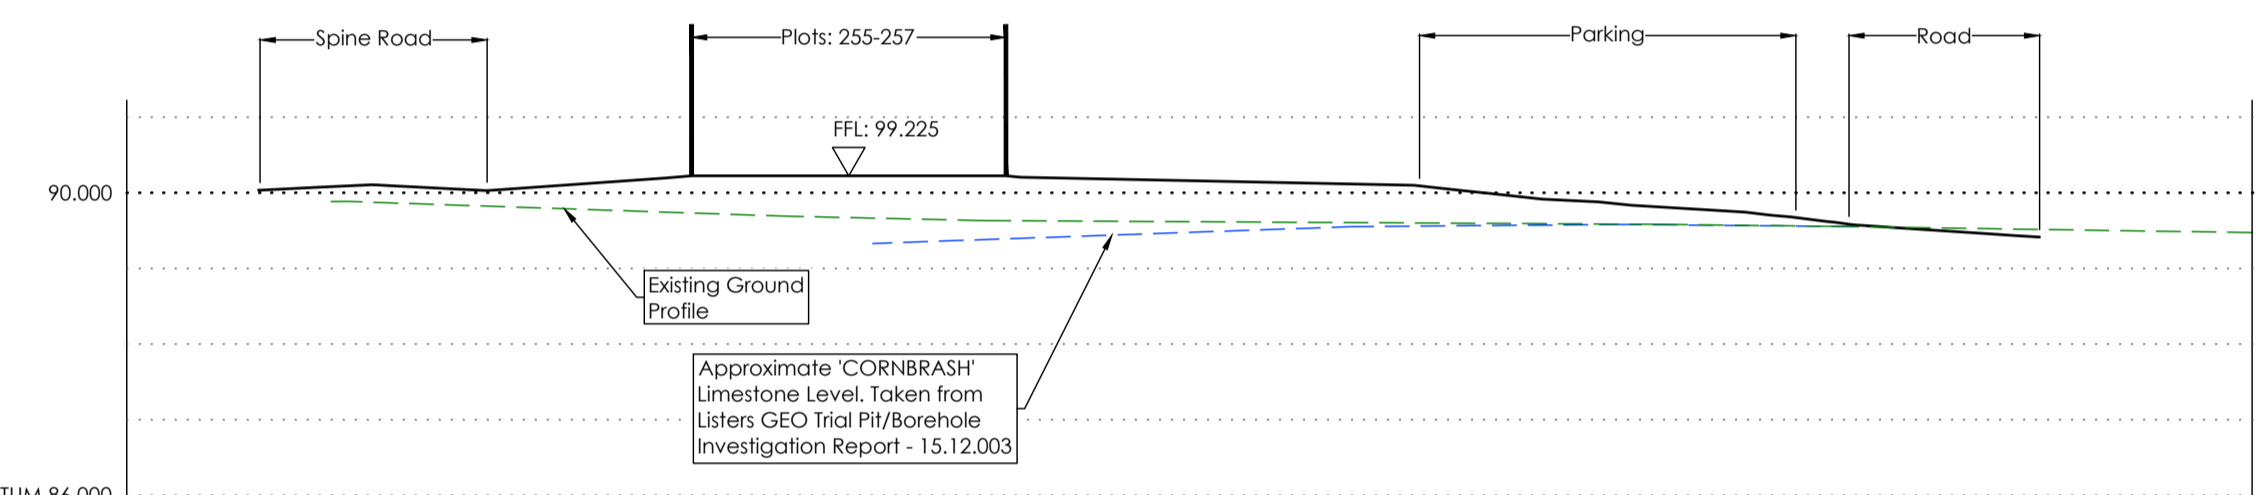

CHAINAGE	0.000	3.463	5.000	10.000	15.000	19.225	25.000	30.000	35.000	40.000	45.000	50.000	55.000	56.225
TRIAL LEVEL						88.330	89.423	89.511	89.583	89.580	89.558	89.551	89.433	89.475
PROPOSED LEVEL		90.037	90.071	90.046	90.225	90.225	90.192	90.141	90.049	89.831	89.620	89.433	89.414	
BASE LEVEL		89.896		89.816	89.732	89.643	89.627	89.613	89.599	89.585	89.557	89.520	89.484	89.475

Section H-I

Scale: 1:200 Horizontal  
1:100 Vertical

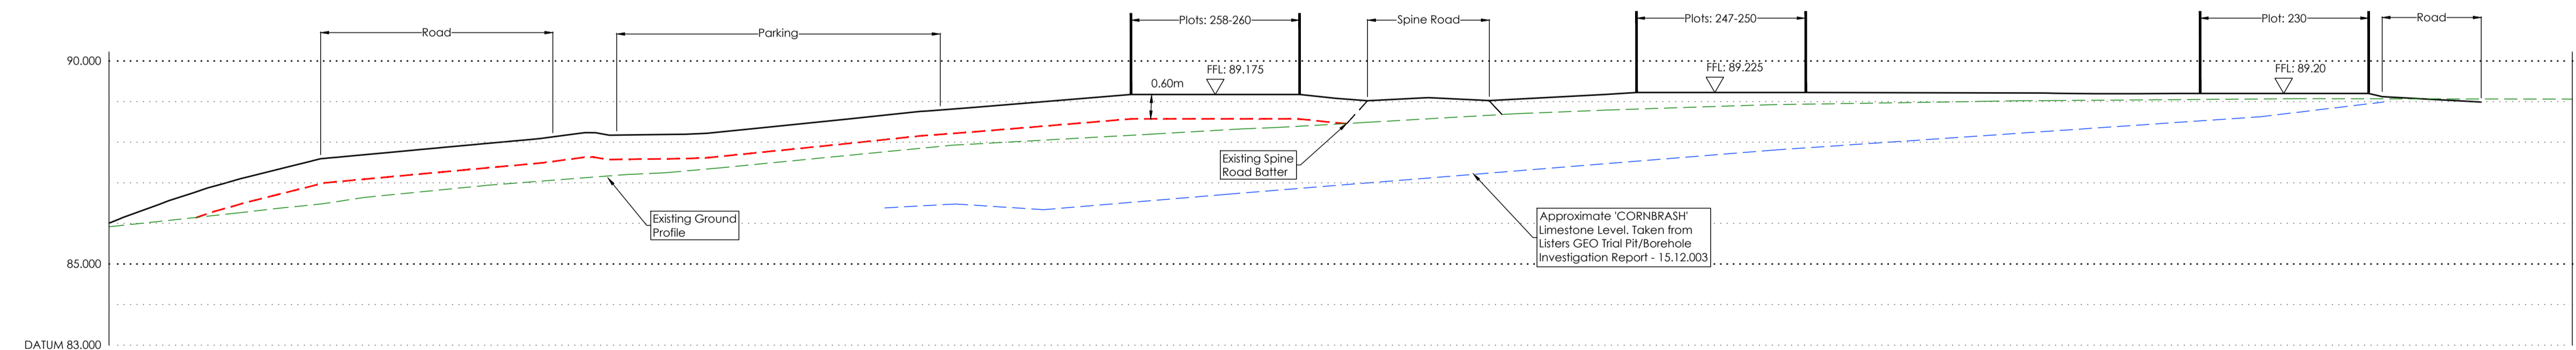

CHAINAGE	0.000	5.000	10.000	15.000	20.000	25.000	30.000	35.000	38.260	40.000	45.000	50.000	55.000	60.000	65.000	70.000	75.000	80.000	85.000	90.000	95.000	100.000	105.000	110.000	112.164	115.000	116.678	120.000	121.476	
TRIAL LEVEL									86.382	86.430	86.572	86.502	86.712	86.914	87.115	87.317	87.519	87.721	87.906	88.077	88.248	88.419	88.590	88.860	88.990	89.043	89.098			
PROPOSED LEVEL	86.005	86.891	87.538	87.803	88.031	88.175	88.245	88.498	88.758	88.758	88.953	89.159	89.175	89.107	89.096	89.076	89.215	89.225	89.224	89.217	89.211	89.194	89.200	89.200	89.200	89.043	88.998			
BASE LEVEL	85.914	86.185	86.455	86.758	86.991	87.183	87.362	87.605	87.849	88.021	88.159	88.303	88.431	88.575	88.714	88.811	88.893	88.947	88.986	89.022	89.041	89.060	89.070	89.067	89.043	89.043	89.043	89.043	89.043	89.043


Section H-H

Scale: 1:200 Horizontal  
1:100 Vertical

**SURVEY INFORMATION**  
MK Surveys - 01908 565561  
DRG NUMBER: 17523 - Sheets 1-12  
DATE RECEIVED: 17/12/2014

**ARCHITECT SITE PLAN INFORMATION**  
RFP Architects - 020 7653 3464  
DRG NUMBER: AA2699  
DATE RECEIVED: 22/12/2015

- NOTES**
- All dimensions and levels are in metres unless otherwise noted
  - This drawing is to be read in conjunction with the relevant Architect's/Engineer's drawings, specifications and CDM documentation
  - This drawings has been produced electronically and may have been photo reduced or enlarged when copied. Work to figured dimensions only (DO NOT SCALE). All dimensions to be checked on site. Any errors or omissions to be reported to the engineer immediately.
  - This drawing contains coloured lines / information that may not be clear if reproduced in black and white.

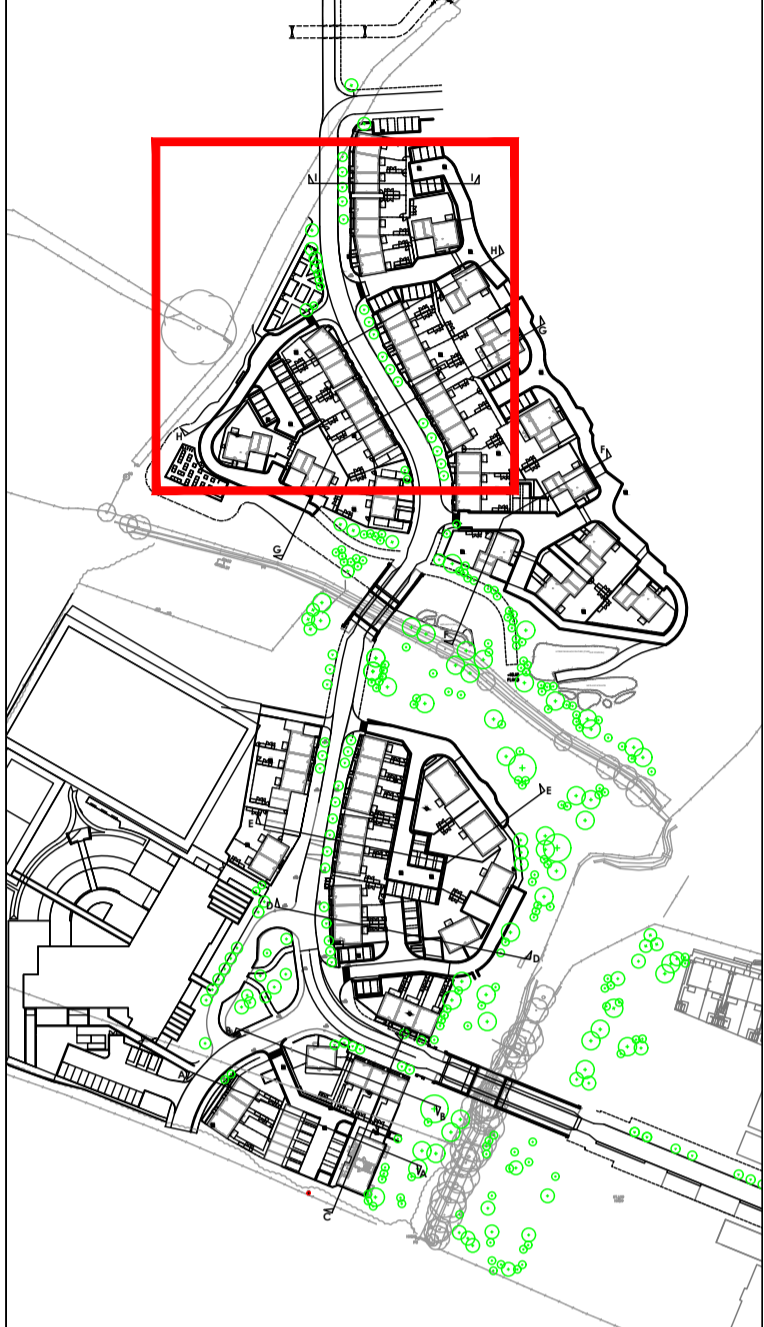

Sheet Arrangement (1:2500)

**Key:**

	Retaining Element
	River Corridor Retaining
	Typical Fill Level

POI	SNN	TST	Initial Issue	Date
				22/02/16

DRAWING TITLE  
**Site Cross Sections**  
Sheet 4 of 4

PROJECT  
**Phase 2**  
**Bicester Eco Village**  
**Bicester**  
**Oxon**

DESIGNED BY <b>TST</b>	DRAFTED BY <b>SNN</b>	APPROVED BY <b>DJ</b>
DATE <b>22/02/2016</b>	STATUS <b>INFORMATION</b>	

SCALE  
**As Noted**

CLIENT

JOB NUMBER <b>15-1859</b>	DRAWING NUMBER <b>44-4</b>	REVISION <b>P01</b>
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