


1:500 @ A0

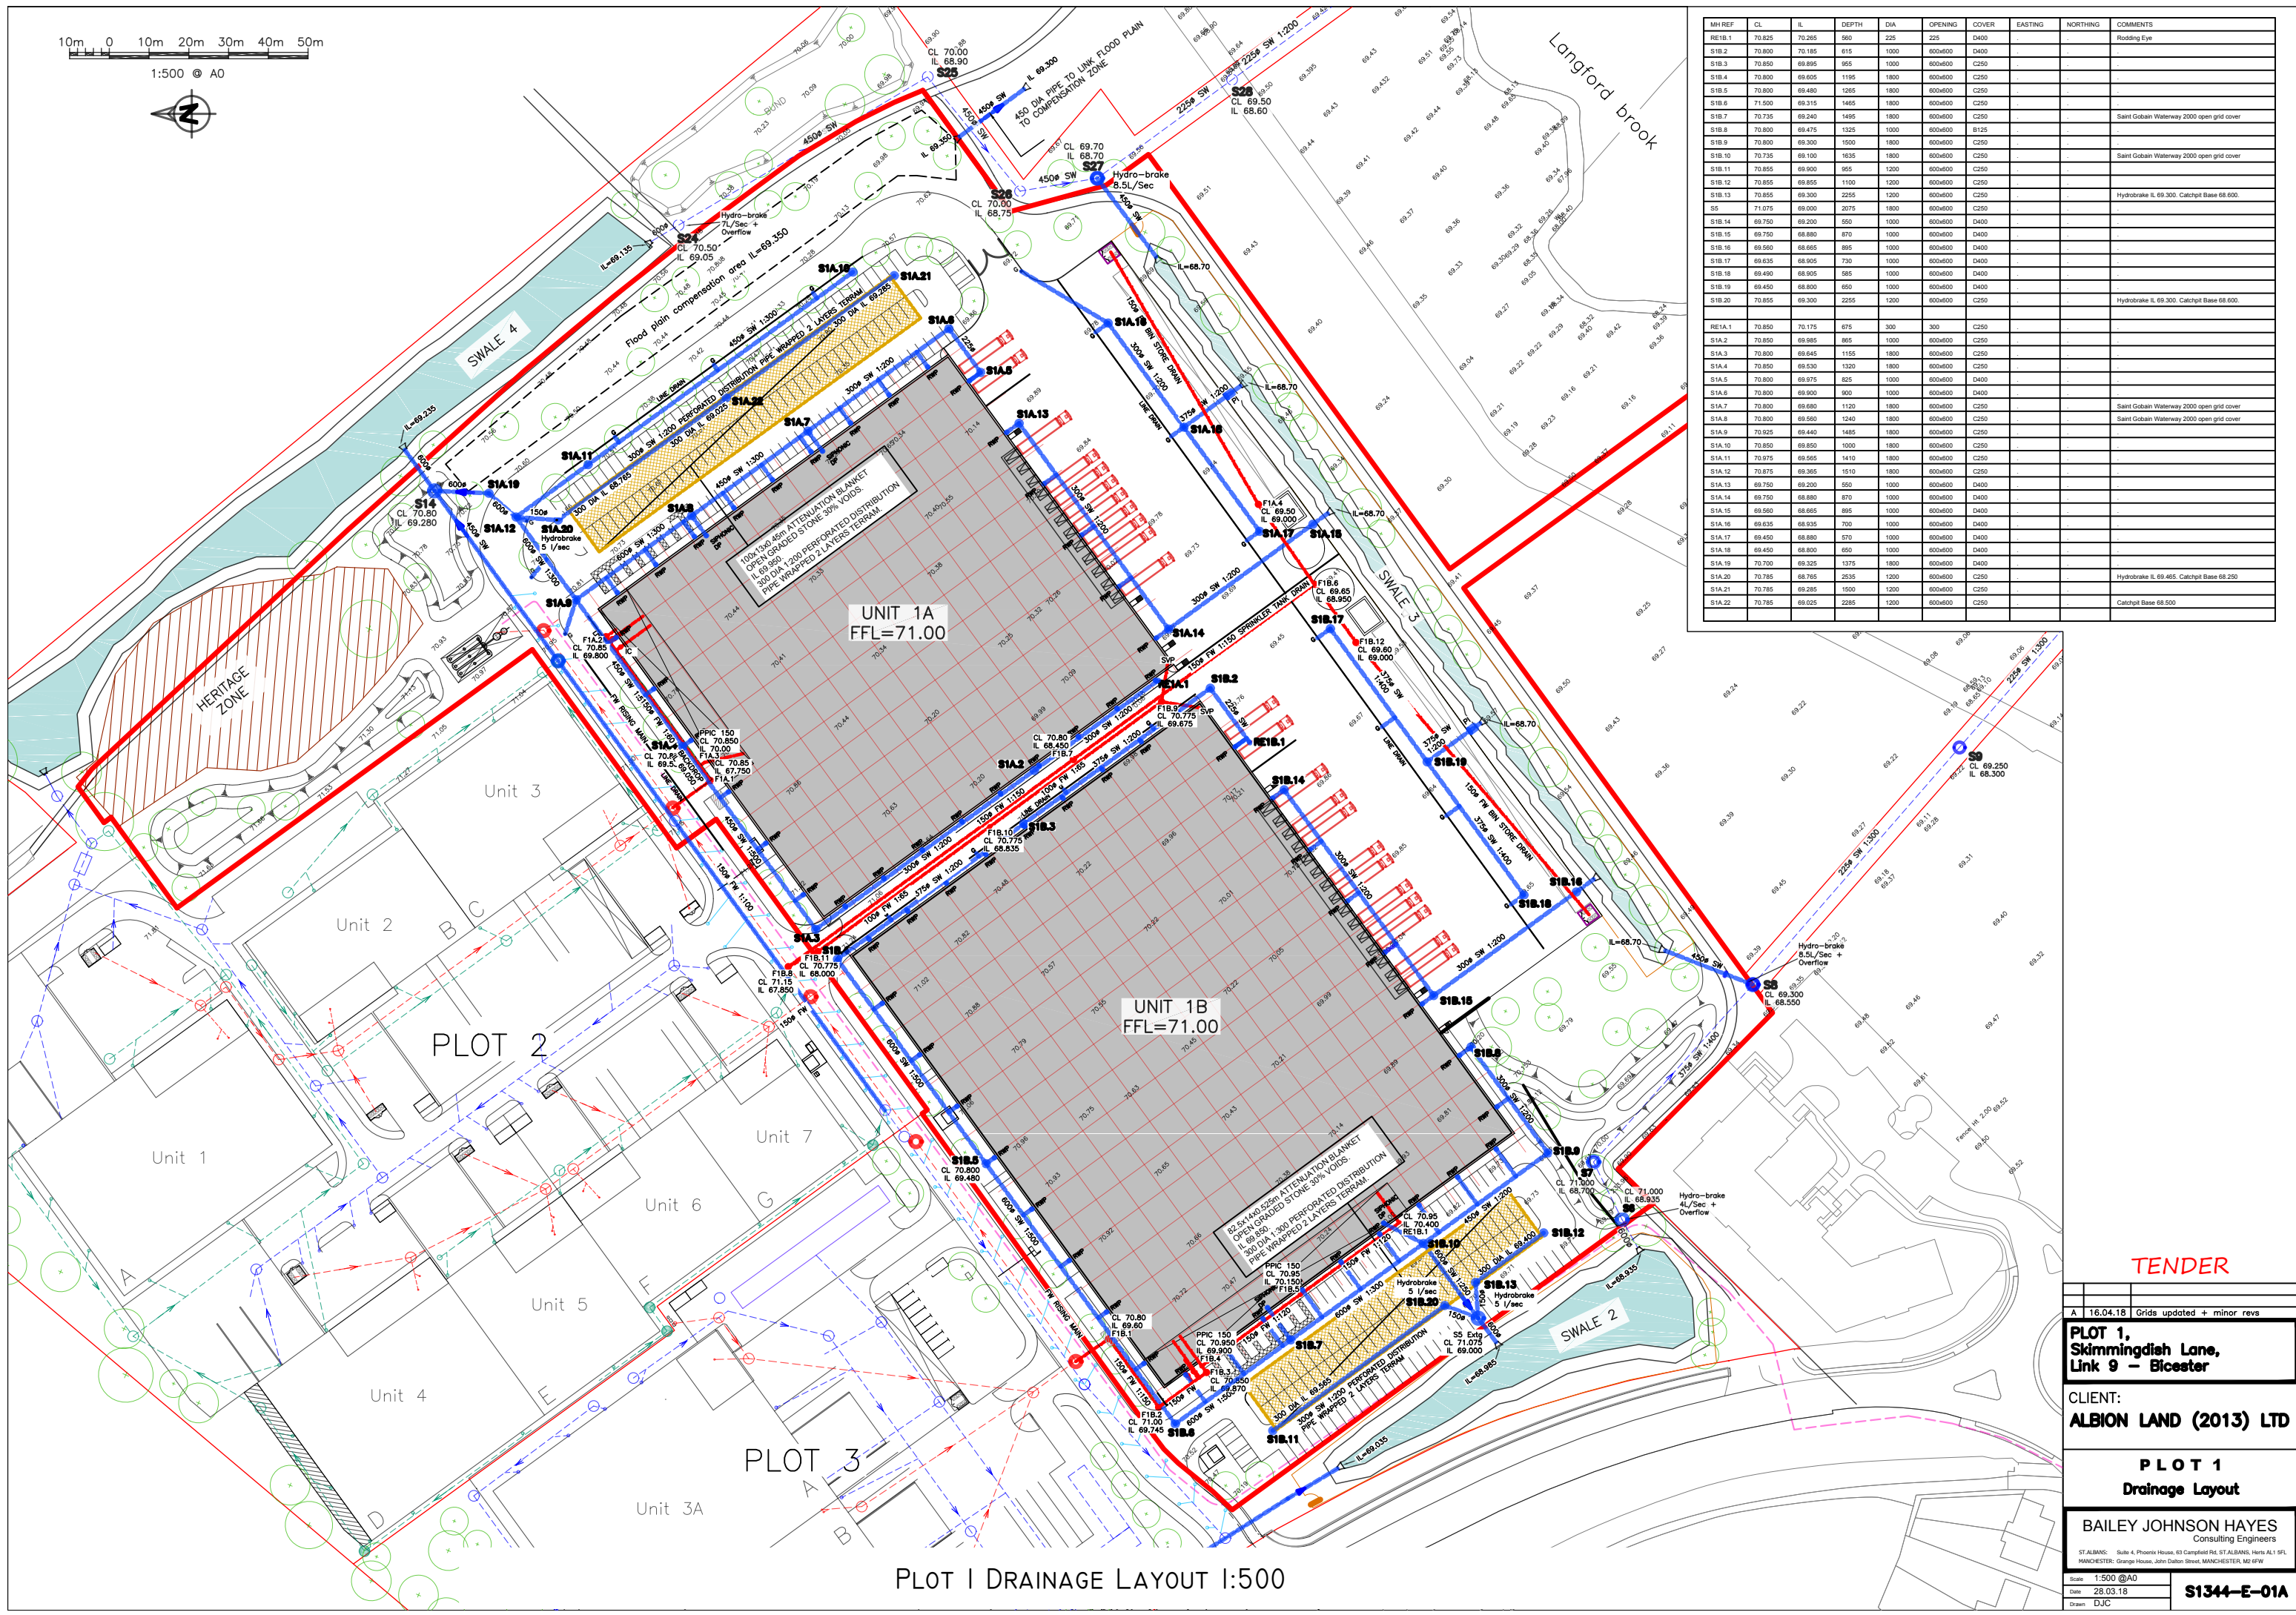

MH REF	CL	IL	DEPTH	DIA	OPENING	COVER	EASTING	NORTHING	COMMENTS
S1B.1	70.825	70.265	560	225	225	D400			Rodding Eye
S1B.2	70.800	70.185	615	1000	600x600	D400			
S1B.3	70.850	69.995	855	1000	600x600	C250			
S1B.4	70.800	69.605	1195	1800	600x600	C250			
S1B.5	70.800	69.480	1285	1800	600x600	C250			
S1B.6	71.500	69.315	1485	1800	600x600	C250			Saint Gobain Waterway 2000 open grid cover
S1B.7	70.735	69.240	1485	1800	600x600	C250			
S1B.8	70.800	69.475	1325	1000	600x600	B125			
S1B.9	70.800	69.300	1500	1800	600x600	C250			
S1B.10	70.735	69.100	1635	1800	600x600	C250			Saint Gobain Waterway 2000 open grid cover
S1B.11	70.855	69.900	955	1200	600x600	C250			
S1B.12	70.855	69.855	1100	1200	600x600	C250			
S1B.13	70.855	69.300	2255	1200	600x600	C250			Hydrobrake IL 69.300. Catchpit Base 68.600.
S5	71.075	69.000	2075	1800	600x600	C250			
S1B.14	69.750	69.200	550	1000	600x600	D400			
S1B.15	69.750	68.880	870	1000	600x600	D400			
S1B.16	69.560	68.665	885	1000	600x600	D400			
S1B.17	69.635	68.905	730	1000	600x600	D400			
S1B.18	69.490	68.905	585	1000	600x600	D400			
S1B.19	69.450	68.800	650	1000	600x600	D400			
S1B.20	70.855	69.300	2255	1200	600x600	C250			Hydrobrake IL 69.300. Catchpit Base 68.600.
RE1A.1	70.850	70.175	675	300	300	C250			
S1A.2	70.850	69.985	865	1000	600x600	C250			
S1A.3	70.800	69.645	1155	1800	600x600	C250			
S1A.4	70.850	69.530	1320	1800	600x600	C250			
S1A.5	70.800	69.975	825	1000	600x600	D400			
S1A.6	70.800	69.900	900	1000	600x600	D400			
S1A.7	70.800	69.680	1120	1800	600x600	C250			Saint Gobain Waterway 2000 open grid cover
S1A.8	70.800	69.560	1240	1800	600x600	C250			Saint Gobain Waterway 2000 open grid cover
S1A.9	70.925	69.440	1485	1800	600x600	C250			
S1A.10	70.850	69.850	1000	1800	600x600	C250			
S1A.11	70.875	69.565	1410	1800	600x600	C250			
S1A.12	70.875	69.365	1510	1800	600x600	C250			
S1A.13	69.750	69.200	550	1000	600x600	D400			
S1A.14	69.750	68.880	870	1000	600x600	D400			
S1A.15	69.560	68.665	885	1000	600x600	D400			
S1A.16	69.635	68.935	700	1000	600x600	D400			
S1A.17	69.450	68.880	570	1000	600x600	D400			
S1A.18	69.450	68.800	650	1000	600x600	D400			
S1A.19	70.700	69.325	1375	1800	600x600	D400			
S1A.20	70.785	68.765	2535	1200	600x600	C250			Hydrobrake IL 69.465. Catchpit Base 68.250
S1A.21	70.785	69.285	1500	1200	600x600	C250			
S1A.22	70.785	69.025	2285	1200	600x600	C250			Catchpit Base 68.500

PLOT 1 DRAINAGE LAYOUT 1:500

TENDER

A 16.04.18 Grids updated + minor revs  
**PLOT 1,**  
**Skimmingdish Lane,**  
**Link 9 - Bicester**

CLIENT:  
**ALBION LAND (2013) LTD**

**PLOT 1**  
**Drainage Layout**

BAILEY JOHNSON HAYES  
 Consulting Engineers

ST ALBANS: Suite 4, Phoenix House, 63 Campbell Rd, ST ALBANS, Herts AL1 5PL  
 MANCHESTER: Orange House, John Dalton Street, MANCHESTER, M2 6FW

Scale: 1:500 @A0  
 Date: 28.03.18  
 Drawn: DJC

**S1344-E-01A**