



Rev	Revision Note	Date	Drawn by	Approved
1-0	Original drawing	05/04/11	AS	KB
1-1	Duct details amended	29/03/12	AS	MS
1-2	Wording of sub station stamp amended	10/09/14	SW	MS
1-3	Minor text changes and note added	16/06/18	MS	MS

FOR FULL BASE DETAIL PLEASE REFER TO GTC SUBSTATION DRAWING GTC-E-SS-001X AND SUBSTATION DOCUMENT GE-TGI-IG-0032

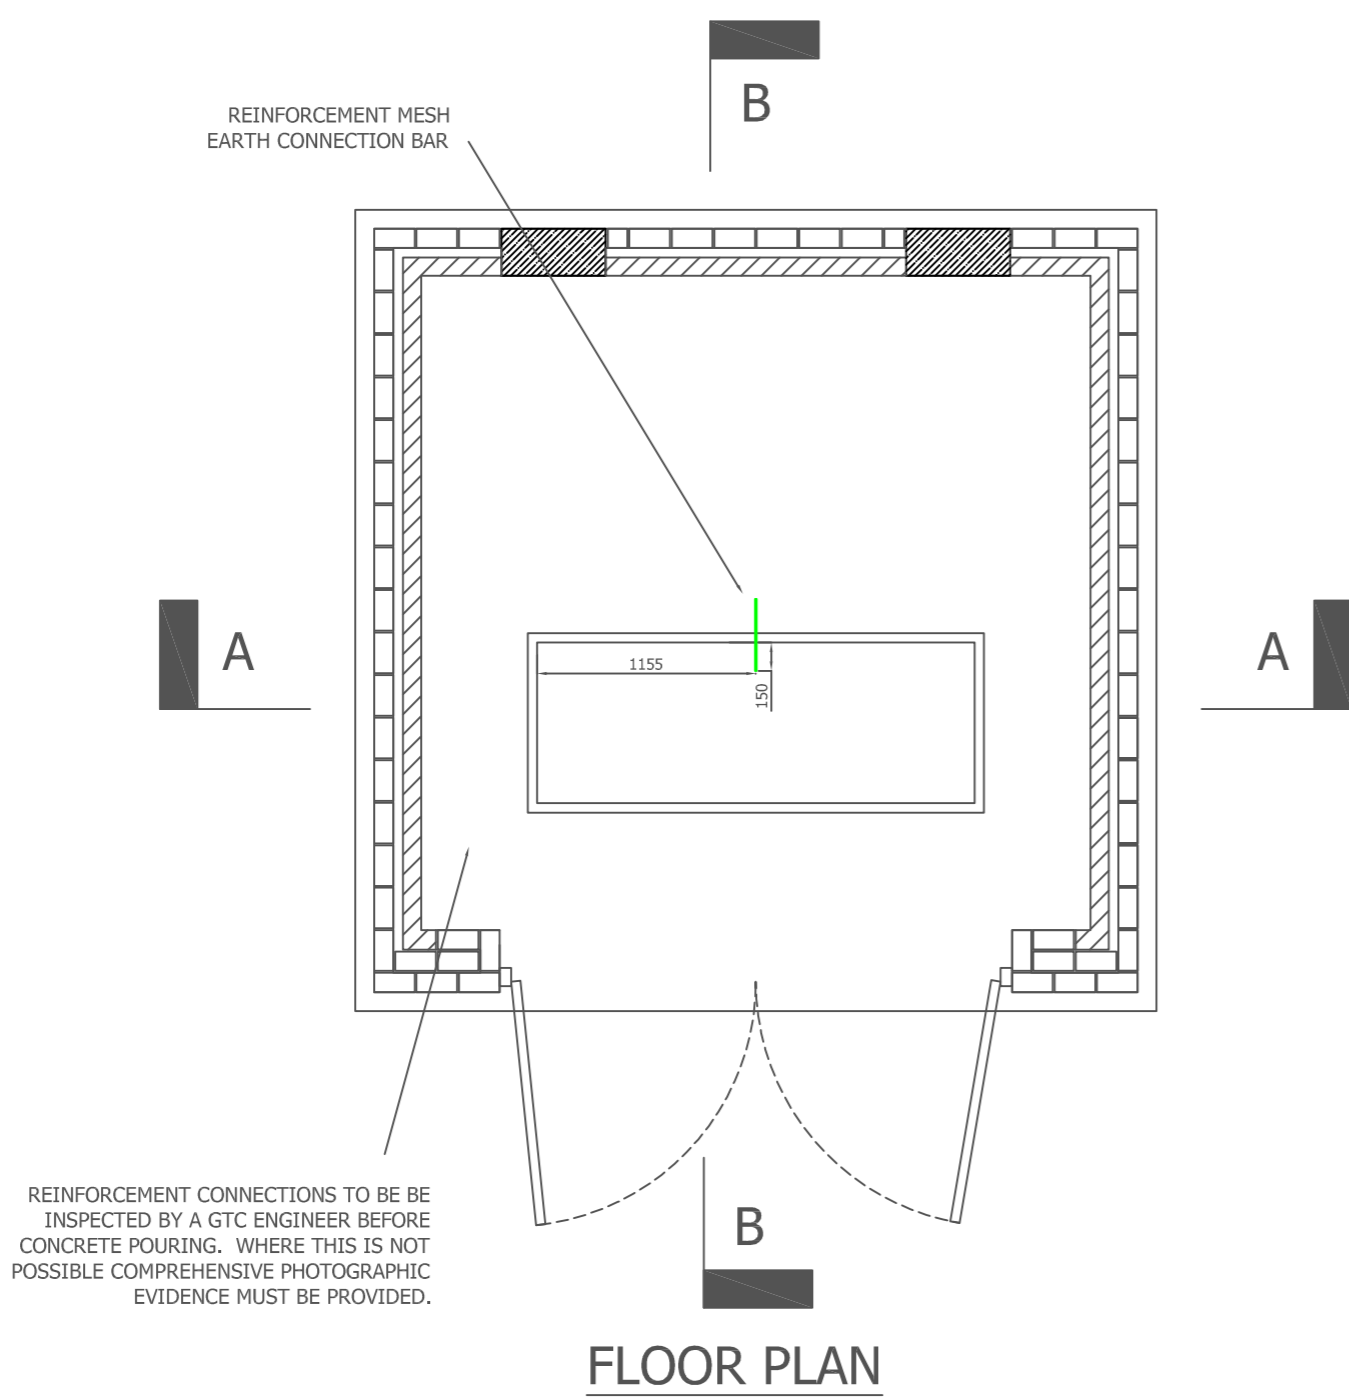


REINFORCEMENT CONNECTIONS TO BE BE INSPECTED BY A GTC ENGINEER BEFORE CONCRETE POURING. WHERE THIS IS NOT POSSIBLE COMPREHENSIVE PHOTOGRAPHIC EVIDENCE MUST BE PROVIDED.


FLOOR PLAN

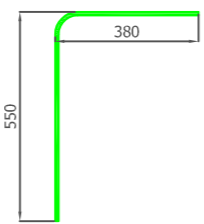

REINFORCING MESH EARTH CONNECTION BAR H10 "L" BAR, 900mm LONG, TO BE WELDED TO REINFORCING MESH TO MAINTAIN MINIMUM 200mm FROM TOP OF FOUNDATION. MIN RE-BAR DIAMETER IS 10mm

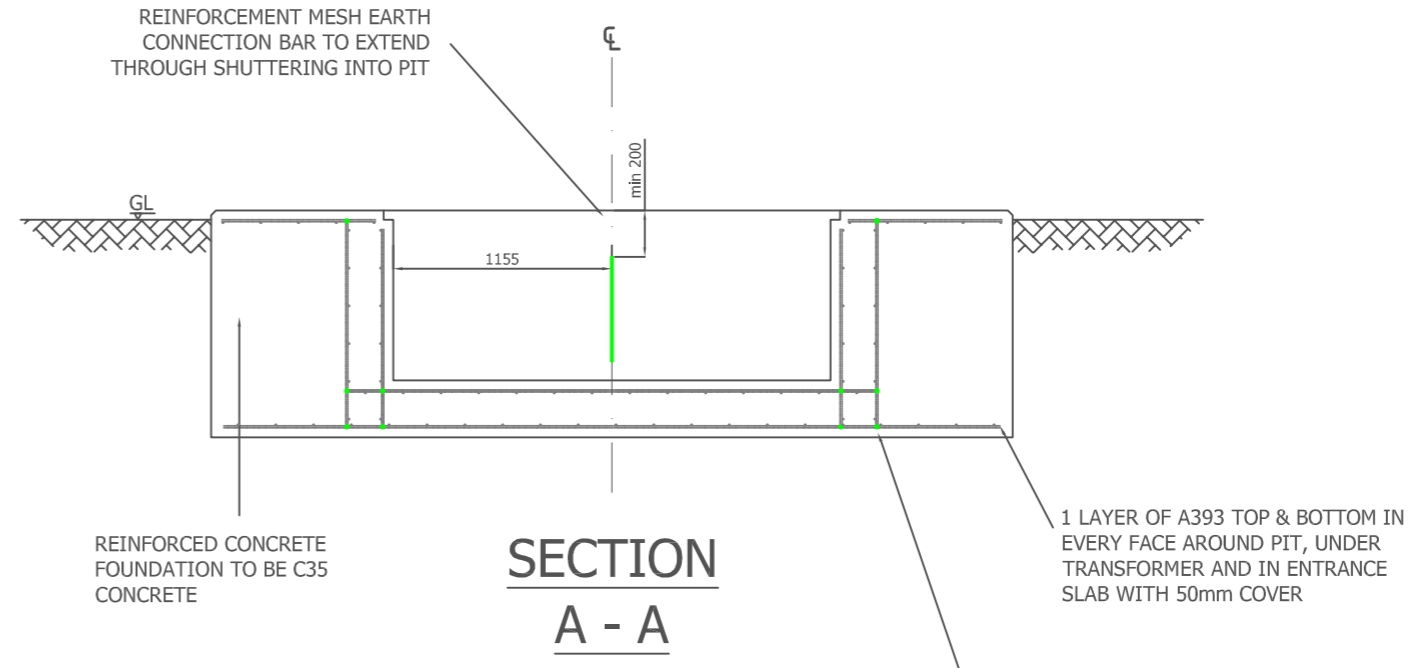

SECTION A - A

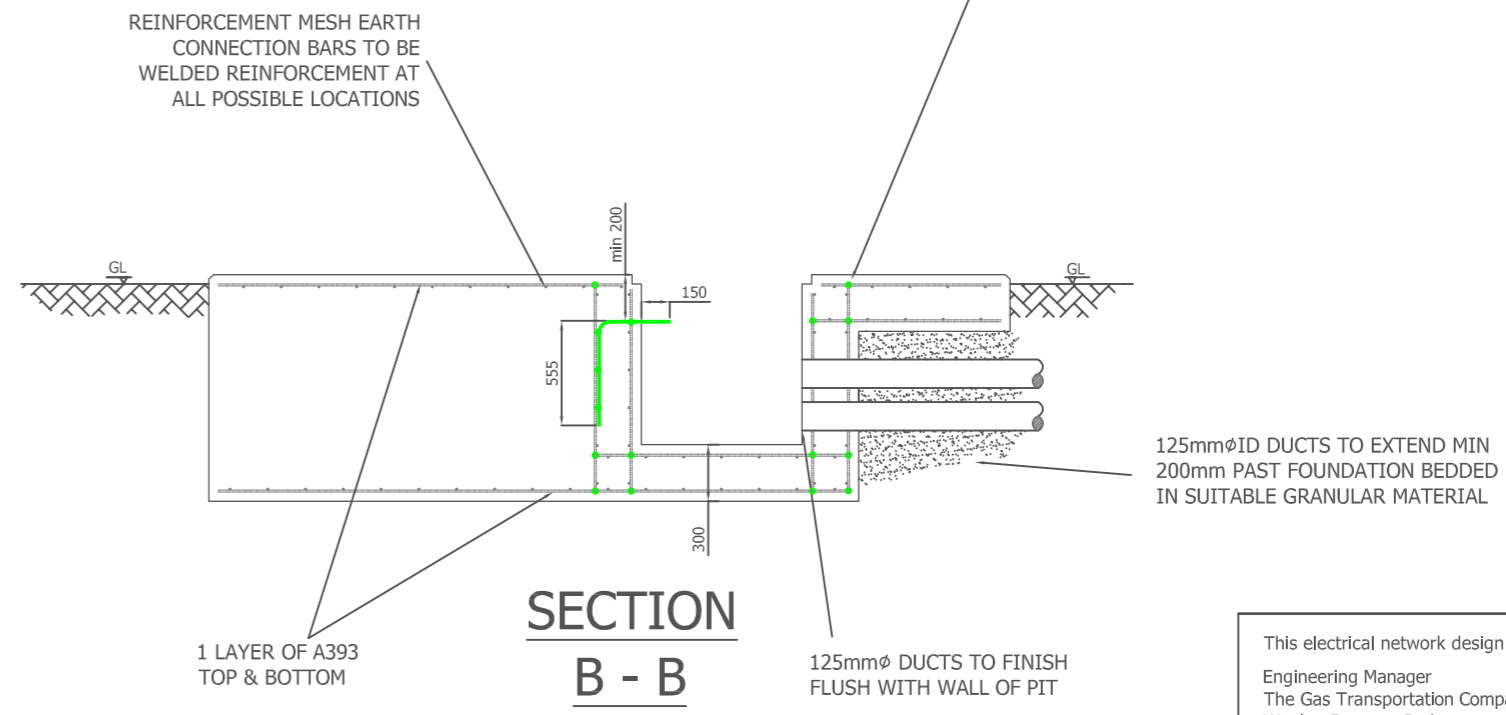

SECTION B - B

This electrical network design has been carried out by :
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 The Gas Transportation Company Ltd Tel : 01359 240363
 Woolpit Business Park Fax : 01359 244398
 Bury St Edmunds Suffolk
 IP30 9UP www.gtc-uk.co.uk
 All cables and equipment used on this design are to be in accordance with GB1 standards.
 © Electricity Networks Company Ltd

THIS DRAWING IS TO BE READ IN CONJUNCTION WITH DRAWING GTC-E-EA-0001 OR GTC-E-EA-0002

APPROVED FOR CONSTRUCTION

Drawing Scale : NOT TO SCALE
 O.S.REF : N/A
 Drawing Number : GTC-E-EA-0003_R1-3
 Description : REINFORCEING MESH EARTH CONNECTION BAR LAYOUT

