GENERAL NOTES

1. THIS DRAWING IS TO BE READ IN CONJUNCTION WITH ALL GENERAL ARRANGEMENT AND PROJECT DETAILS DRAWINGS

3. ABBREVIATIONS USED:
EMJ EXTERNAL MOVEMENT JOINT
HL AT HIGH LEVEL
AAV AIR ADMITTANCE VALVE
SVP SOIL AND VENT PIPE
DP DRAINAGE POINT
RWP RAIN WATER PIPE
CJ CONSTRUCTION JOINT

FACING BRICKWORK / RENDER FINISH ON 7.2N BLOCKWORK

ZZZ ENGINEERING BRICKWORK IN LINE WITH STRUCTURAL ENGINEERS SPECIFICATION

ZZZZ 3.6N/SQ. MM AIRCRETE BLOCK (550 - 650 KG/M²) TO CLIENTS SPECIFICATION. BLOCK STRENGTH TO BE IN ACCORDANCE WITH THE STRUCTURAL ENGINEERS DETAILS. PARTY WALL IN ACCORDANCE WITH ROBUST DETAIL E-WM-30.

ACCORDANCE WITH ROBUST DETAIL E-WM-30.

NON-LOADBEARING PARTITION AS FOLLOWS:
70MM GYPFRAME 'C' STUDS WITH 12.5 MM PLASTER BOARD.
MOISTURE RESISTANT BOARD TO BE USED IN WET AREAS.
PLY INFILL BETWEEN STUDS TO BE USED TO SUPPORT
RADIATORS / KITCHEN WALL UNITS ALL IN ACCORDANCE WITH
THE CLIENTS SPECIFICATION AND DETAIL.
25MM ISOVER APR 1200 IN THE STUD CAVITY OR EQUIVALENT
40DB APROVED MATERIAL (TO CLIENT SPECIFICATION) TO ALL
BATHROOMS AND BETWEEN BEDROOMS / LIVING SPACES AS
INDICATED

PLY 12 MM PLY FOR SANITARYWARE BASIN'S AND WC'S INCLUDING BOXING, STUD WALLS AND BUTTRESS WALLS AS INDICATED

■ ■ BUTTRESS WALLS 75MM X 100MM TIMBER STUD + 12MM PLY LINING TO STRUCTURAL ENGINEER'S DETAILS

DENOTES SPAN OF FLOOR OVER (TYPE STATED)

B&B BEAM & BLOCK
TJ JOIST SPAN
T TRUSS

5. SB DENOTES STRUCTURAL BEAM OVER.
FOR ALL STRUCTURAL STEELWORK, PADSTONES, AND MOVEMENT JOINT DETAILS REFER TO THE STRUCTURAL ENGINEER'S DRAWINGS.

6. ALL DRAINAGE RUNS TO BE ABOVE FLOOR UNLESS STATED OTHERWISE.

7. ALL KITCHEN LAYOUTS TO SPECIALIST'S DESIGN AND DETAILS

8. CONTINUOUS MECHANICAL EXTRACTS ALL EXTRACT DUCTS TO BE WITHIN THE FLOOR / ROOF SPACE UNILESS NOTED OTHERWISE, REFER TO SPECIALIST'S DRAWINGS FOR DETAILS


E INDICATES EXTRACT LOCATION

DENOTES SMOKE ALARM - TO BE SELF CONTAINED, MAINS FED & INTERCONNECTED, TO COMPLY WITH B.S. 5446 PART 1.

HD HEAT DETECTOR A100 EI 144 WITH BATTERY BACK UP

10. FOR MOVEMENT JOINT, BED JOINT REINFORCEMENT AND ALL STRUCTURAL INFORMATION REFER TO STRUCTURAL ENGINEERS DRAWINGS AND DETAILS

11. ALL SVP'S TO BE INSULATED WITH MIN 25MM INSULATION QUILT AND TO BE BOXED IN WITH 25X50 SW TIMBER BATTEN FRAMEWORK AND 2NO LAYERS OF 12.5MM PLASTERBOARD.

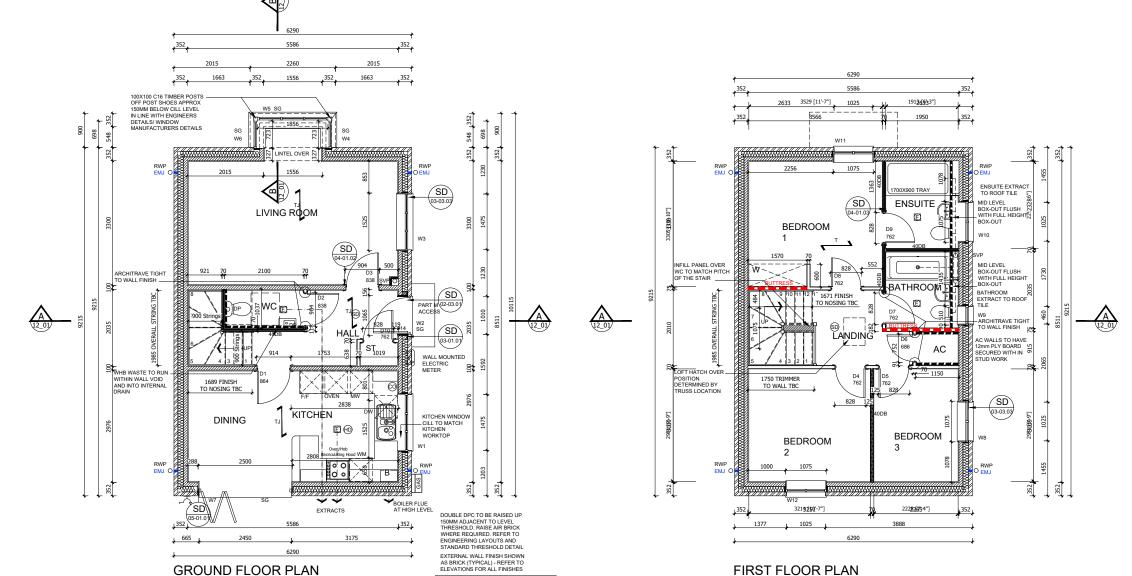

WINDOW/EXTE	RNAL DOOR SCHEDULE				
REF	WIDTHXHEIGHT	ROOM NAME	LINTEL REF.	SAFETY GLAZING	REMARKS
W1	1525 X 1350	KITCHEN	L1	PAS 24	MIN 2500MM ² TRICKLE VENTILATION
W2	1065 X 2400	ENTRANCE HALL	L2	PAS 24	914X2000 DOOR LEAF WITH FAN LIGHT OVER - PART M ACCESS
W3	1525 X 1350	LIVING ROOM	L3	PAS 24	MIN 2500MM ² TRICKLE VENTILATION
W4	723 X 1350	LIVING ROOM	N/A	PAS 24	MIN 2500MM2 TRICKLE VENTILATION
W5	1856 X 1350	LIVING ROOM	L4 SPECIAL	PAS 24	MIN 2500MM ² TRICKLE VENTILATION
W6	723 X 1350	LIVING ROOM	N/A	PAS 24	MIN 2500MM ² TRICKLE VENTILATION
W7	2500X 2100	DINING ROOM	L7	PAS 24	BI-FOLDS
W8 #	1075 X 1350	BEDROOM 3	L8	NO	MIN 2500MM ² TRICKLE VENTILATION P1A GLAZING
W9	510 X 1200	BATHROOM	L9	NO	OBSCURE GLAZING P1A GLAZING
W10 OB	1075 X 1350	ENSUITE	L10	NO	OBSCURE GLAZING P1A GLAZING
W11 #	1075 X 1350	BEDROOM 1	L11	NO	MIN 2500MM ² TRICKLE VENTILATION P1A GLAZING
W12 #	1075 X 1350	BEDROOM 2	L15	NO	MIN 2500MM ² TRICKLE VENTILATION P1A GLAZING
М	VENTILATION REQUIR ALL WINDOWS TO HA		EM 3 VIA CONTINUOUS	MECHANICAL VENTILATION	IN ACCORDANCE WITH AD PART F

2) ALL WINDOWS TO HAVE EASY CLEAN HINGES
3) REFERENCES FOR OPENINGS:W= WINDOW OR EXTERNAL DOOR, SG = SAFETY GLAZING, OB = OBSCURED GLAZING
#= INDICATES EMERCENCY ESCAPE WINDOW TO COMPLY WITH AD PART B1
4) WINDOWS & DOOR CLIL REQUIREMENTS AS FOLLOWS:
BRICK WORK - TO HAVE EXTENDED CILL TO WINDOWS (STANDARD CILL TO DOORS)
CAST STONE CILLS - TO HAVE STUB CILL
TILED CILLS - TO HAVE STANDARD CILL

SAFETY GLAZING TO BE INSTALLED IN ALL EXTERNAL DOORS AND THE BOTTOM PANE ONLY OF WINDOWS AS NECESSARY, GLAZING TO COMPLY WITH AD 5) SAPETY GLAZING 10 BE INSTALLED IN ALL EXTERNAL DOORS AND THE BOTT ON PANE UNITY OF WINDOWS AS RELESSARY, GLAZING 10 COMPLY WITH A PART IN, CITE BOTTOM PANE ONLY OF 1ST FLOOR WINDOWS IS TO ACT AS GUARDING AGAINST FALLING AS RECESSARY, THESE WINDOWS MUST HAVE AN INTERNAL PANE OF LAMINATED GLASS, AND BOTH PANE AND FRAME OF ESSIST THE HORIZONTAL FORCE GIVEN IN 85539-PARTI:1996.

FOR DETAIL OF LINTERS FEER TO MANUFACTURERS SCHOOLIES, ALL INITIES IN EXTERNAL WALLS TO BE FITTED WITH INTEL SOFFIT CLADDING AND WITH FLIXIBLE DIPM IN ACCORDANCE WITH MANUFACTURES INSTRUCTIONS

7) ALL WINDOW AND DOOR SIZES TO BE CHECKED ON SITE PRIOR TO MANUFACTURE

REF /	DOOR LEAF SIZE	STRUCTURAL OPENING WIDTH X HEIGHT	ROOM NAME	LINTEL REF.	REMARKS
D1	864 X 1981	914 X 2050	KITCHEN	L14	100MM BLOCK WALL, PARLIAMENT HINGES
D2	838 X 1981	904 X 2050	WC		
D3	838 X 1981	904 X 2050	LIVING ROOM	L15	100MM BLOCK WALL
D4	762 X 1981	828 X 2050	BEDROOM 2		
D5	762 X 1981	828 X 2050	BEDROOM 3		
D6	686 X 1981	752 X 2050	AIRING CUPBOARD		
D7	762 X 1981	828 X 2050	BATHROOM		
D8	762 X 1981	828 X 2050	BEDROOM 1		
D9	762 X 1981	828 X 2050	ENSUITE		
D10	762 X 1981	828 X 2050	STORE		
NOTES	2) ALLOW 10MM A 3) FOR DETAILS O 4) STRUCTURAL O VARY FOR ANY	OOR, FD= FIRE DO IR GAP UNDER DOOR F LINTELS REFER TO PENING SIZES BASE OTHER DOOR FRAME	S TO ALL ROOMS MANUFACTURED D ON LEAF SIZE SIZE.	S EXCEPT STOR R'S SCHEDULES + 35X2 DOOR FR	

NOTE: RENDERED UNITS REQUIRE 20MM OF KNOCK WITHIN WINDOWS TO ALLOW CLEARANCE WITH RENDERED RETURN

REA SCHEDULE REF / GROSS AREA NET AREA m² 48.51 522 49.31 530 46.78 503 47.54 511 95.29 1025 96.85 1041

GROSS AREA = AREA MEASURED WITHIN THE BOUNDARY OF THE INNER STRUCTURAL FACE OF THE EXTERNAL WALL AND SLOPING CEILINGS AT 1200MM ABOVE FFL.

GENERAL NOTES (EXTERNAL DOOR & WINDOW SCHEDULE)

ALL EXTERNAL DOOR & WINDOW SCHEDULES ARE TO BE READ IN CONJUNCTION WITH CONSTRUCTION SPECIFICATION.

CONSTRUCTION SPECIFICATION.

CONSTRUCTION SPECIFICATION.

GENERAL ARRANGEMENT FLOOR R LANS AND ELEVATIONS.

GENERAL ARRANGEMENT FLOOR PLANS AND ELEVATIONS.

STRUCTURAL & SUFFICIENT TO LERANCE MUST BE ALLOWED FOR THE THICKNESS OF THE CANTY CLOSER'S BUILDING THE WINDOW WITHIN THE STRUCTURE OR POST FIXING.

WINDOW. ALL CAVITY BARRIERS/CLOSERS TO BE A MINIMUM 30 MINUTES FIRE RATED IN

ALL CAVITY BARRIERS/CLOSERS TO BE A MINIMUM 30 MINUTES FIRE RATED IN ACCORDANCE WITH APPROVED PART B GUIDELINES.
FOR FULL DETAILS OF LINTELS OVER OPENINGS, REFER TO MANUFACTURERS DETAILS AND STRUCTURAL ENGINEERS DESIGN DETAILS. A SPECIFICATION.
PROVIDE STANDARD DOUBLE GLAZED (BS EN 1279-1:2004) DRAUGHT SEALED PVCu WINDOWS MANUFACTURED TO BS 7412.

OBSCURE GLAZING TO WCS. ENSUITES A BATHROOMS.
ALL ESCAPE WINDOWS TO HAVE PITA APPROVED GLAZING.
ALL GROUND FLOOR & EASILY ACCESSIBLE WINDOWS TO BE DESIGNED TO PASS4:2016.
ALL WINDOWS TO BE FITTED WITH RESTRICTORS FOR SECURITY AND TO PROVIDE VENTILATION TO AVOID SUMMER OVER HEATING.

ALL WINDOWS TO BE FITTED WITH EASY CLEAN HINGES. ALL WINDOWS ABOVE GROUND FLOOR TO BE FITTED WITH RESTRICTORS WITH A RELEASE CATCH.
GLAZING BELOW 800mm(MEASURED FROM FLOOR LEVEL) IN SCREENS AND WINDOWS AND
BELOW 1500mm(MEASURED FROM FLOOR LEVEL IN DOORS) INCLUDING ANY SIDELIGHTS
WITHIN 300mm OF THE DOOR SHALL BE TOUGHENED SAFETY GLASS TO BE 6262: PART 4.

PHASE 9A PLOT - (AS) 515, 542

- (OPP) 524,525

PHASE 9B PLOTS - (AS) 552, 586 (OPP) 544, 545, 584, 603

PHASE 9C PLOTS - (AS) 643, 654 PHASE 9D PLOTS - (AS) 672, 725, 743 - (OPP) 691, 702, 741

	1m	2m	3m	4r
Client:				
	Г	OORCHESTER	3.	
, =		rower I		
Site Address: UPPER BICEST	HEYFO	RD, PHASE	≣ 9	
	TYPE 1	A (sa) ST FLOOR	PLANS	
Scale: 1:50 @ A	.1	Date drawn: FEB 21		Dra M.
	er:	Drawing Number:		Rev

19.02.21 Construction Issue 22.04.21 Phase 9A handing corrected 18.05.21 Wardrobe space indicated to bed 1 21.05.21 40db walls noted, minor updates