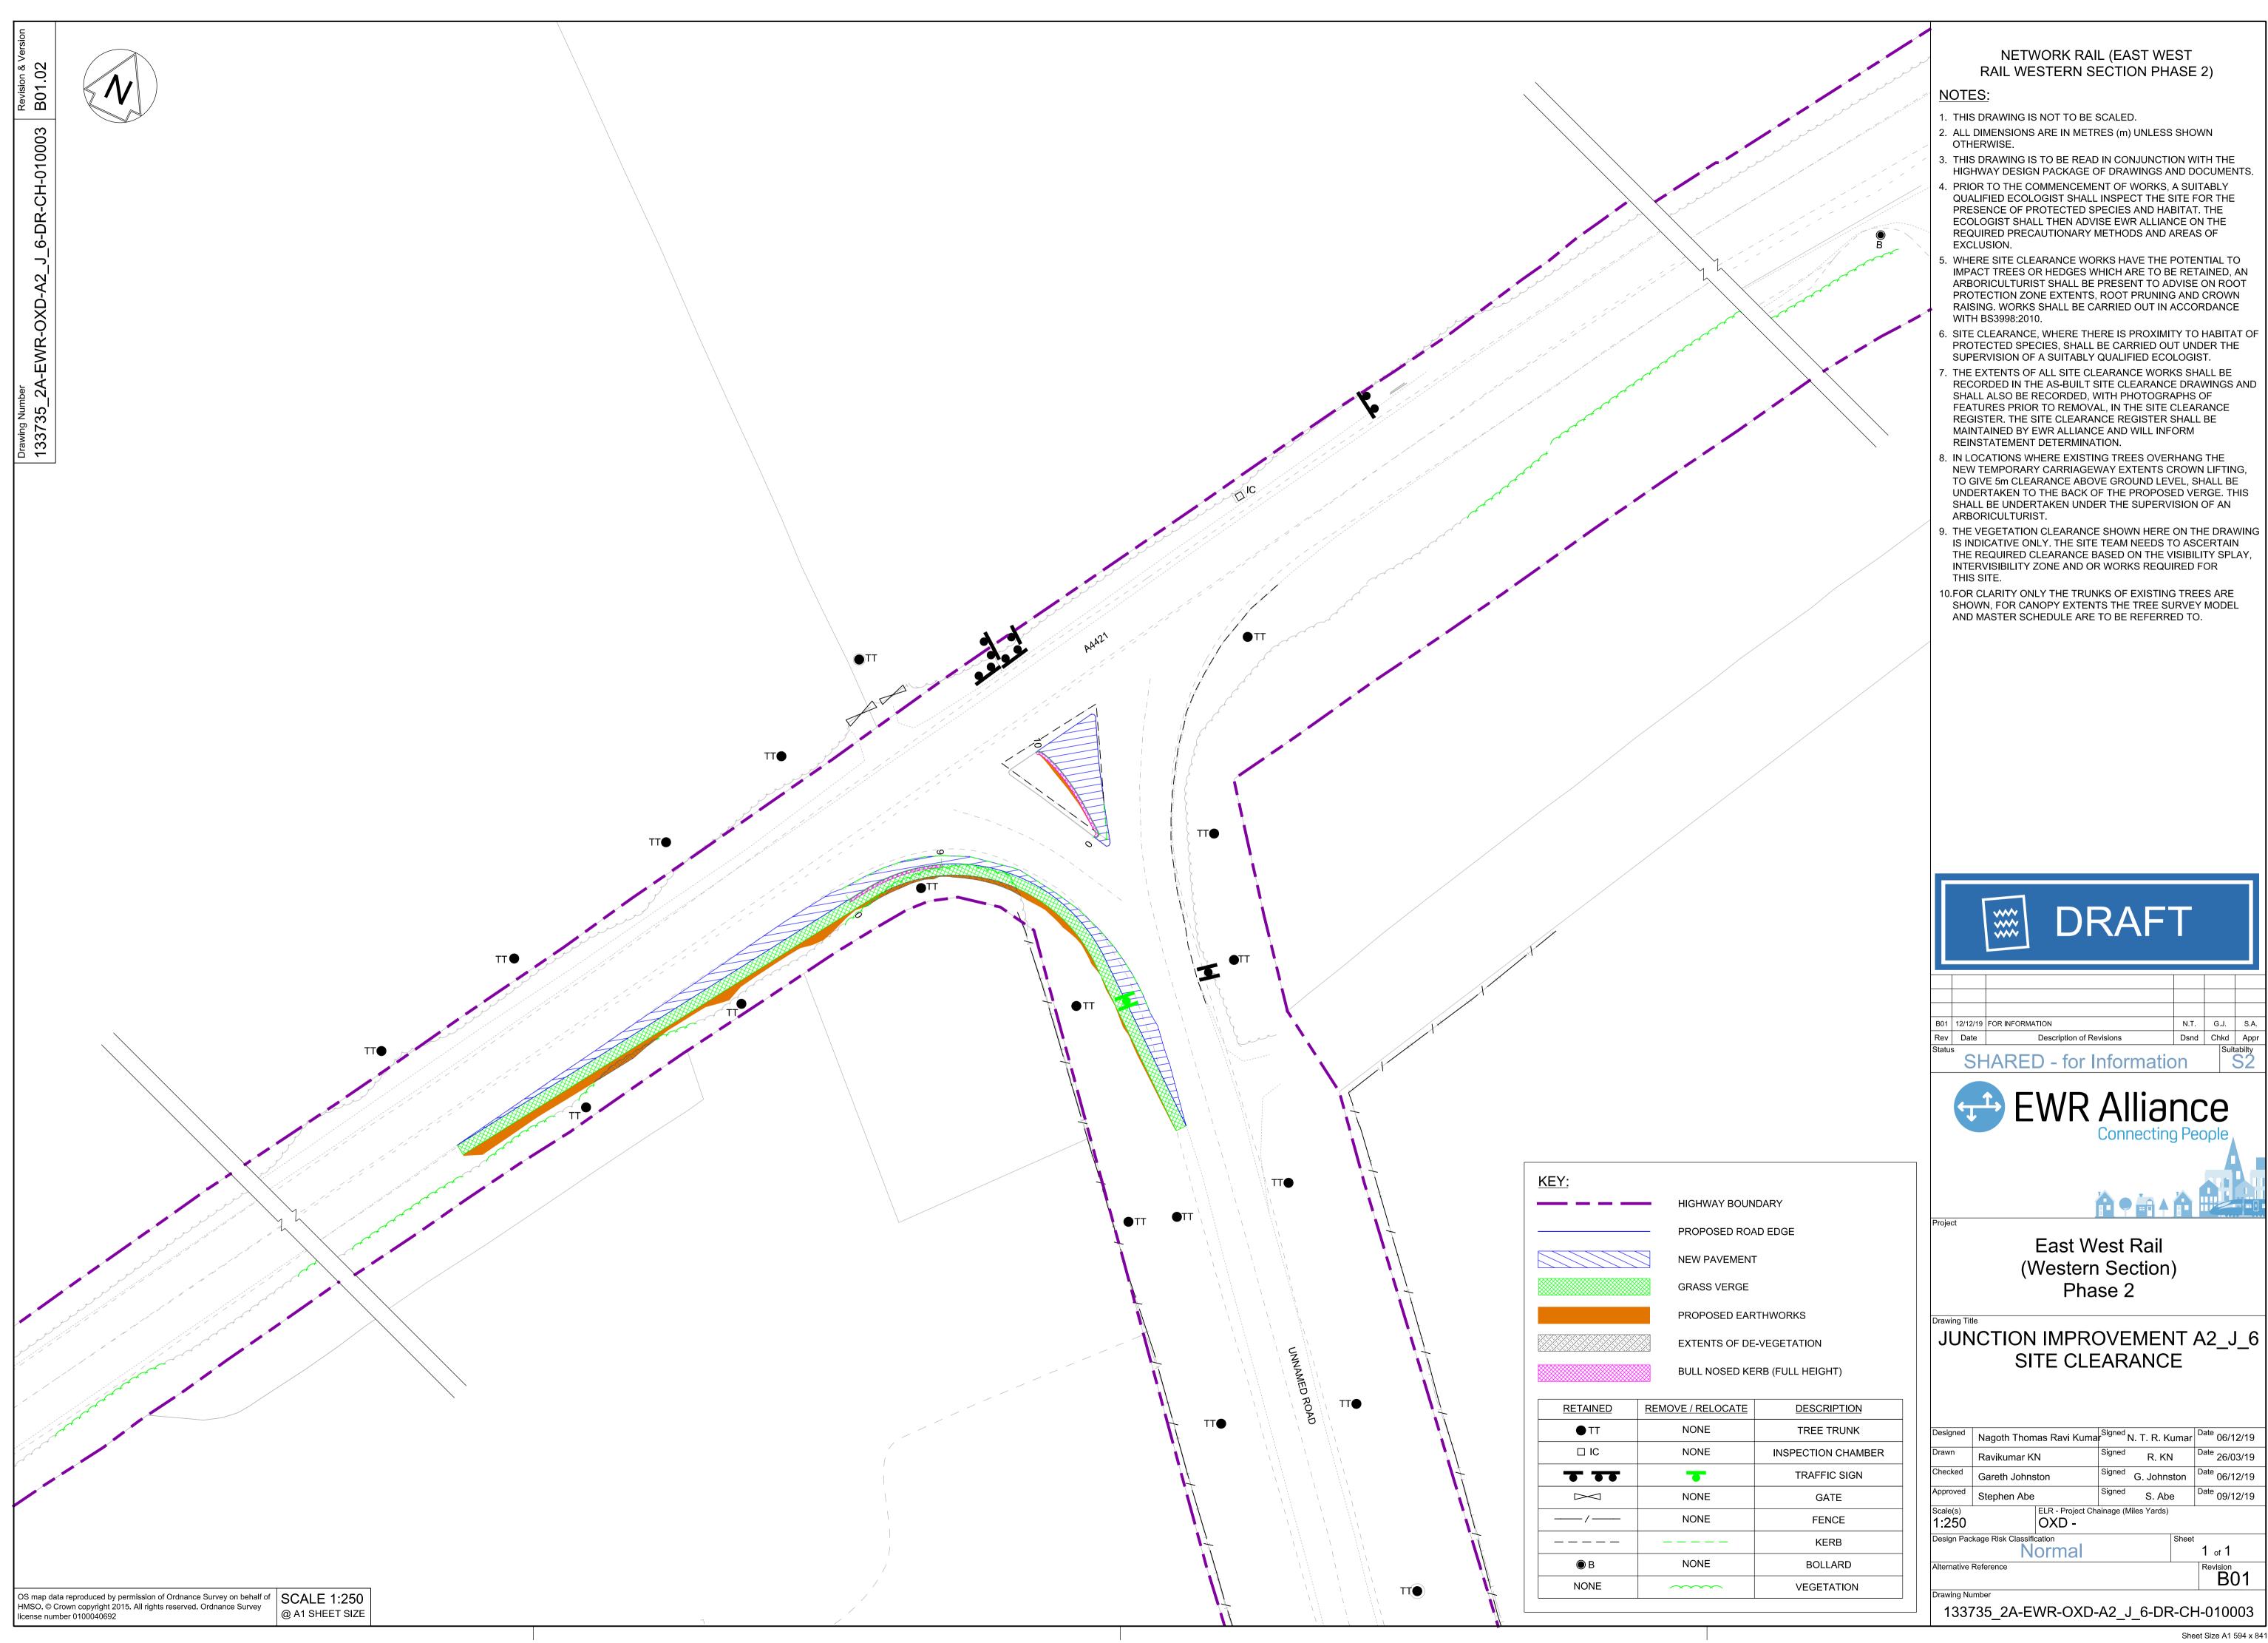
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	<ul> <li>NETWORK RAIL (EAST WEST RAIL WESTERN SECTION PHASE 2)</li> <li>NOTES: <ol> <li>THIS DRAWING IS NOT TO BE SCALED.</li> <li>ALL DIMENSIONS ARE IN METRES (m) UNLESS SHOWN OTHERWISE.</li> <li>THIS DRAWING IS TO BE READ IN CONJUNCTION WITH THE HIGHWAY DESIGN PACKAGE OF DRAWINGS AND DOCUMENTS.</li> <li>WHEREVER REQUIRED, ROAD MARKINGS ARE TO BE LAID IN ACCORDANCE WITH 'THE TRAFFIC SIGN REGULATIONS AND GENERAL DIRECTIONS 2016' &amp; 'TRAFFIC SIGNS MANUAL CHAPTER 5 (2003)'.</li> <li>A POTENTIAL ARCHAEOLOGICAL CONSTRAINT EXISTS AT OR IN PROXIMITY TO THIS SITE. AN ARCHAEOLOGIST WATCHING BRIEF IS REQUIRED DURING CONSTRUCTION WORKS.</li> <li>WHERE A FENCE IS PROPOSED IT SHALL TIE-IN TO THE EXISTING HEDGEROW OR BOUNDARY TREATMENT TO PROVIDE A SECURE BOUNDARY.</li> </ol></li></ul>
	DRAFT
	B01     12/12/19     FOR INFORMATION     N.T.     L.T.     S.A.       Rev     Date     Description of Revisions     Dsnd     Chkd     Appr       Status     Suitability
	SHARED - for Information S2
	EWR Alliance
HIGHWAY BOUNDARY	Connecting People
EXISTING ROAD EDGE	
	Project
	East West Rail
NEW PAVEMENT	(Western Section)
PROPOSED EARTHWORKS	Phase 2
BULL NOSED KERB (FULL HEIGHT)	Drawing Title JUNCTION IMPROVEMENT A2 J 6
RELOCATED TRAFFIC SIGN	GENERAL ARRANGEMENT
PROPOSED POST & WIRE FENCE	
PROPOSED GULLY	Declared
	DesignedNagoth Thomas Ravi KumarSigned N. T. R. KumarDate 06/12/19DrawnRavikumar KNSigned R. KNDate 26/03/19
	Checked Lisa Taylor Signed L. Taylor Date 09/12/19
VERY TEAM, AND THEREFORE ONLY WITH THIS DRAWING ARE SAFETY MEASURES REFER	Approved     Stephen Abe     Signed     S. Abe     Date     09/12/19       Scale(s)     ELR - Project Chainage (Miles Yards)
33735-NWR-RSA-SSD-000001.	1:250     OXD -       Design Package Risk Classification     Sheet
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&S RISKS )	Drawing Number
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Sheet Size A1 594 x 841



# JUNCTION IMPROVEMENT A2\_J\_6

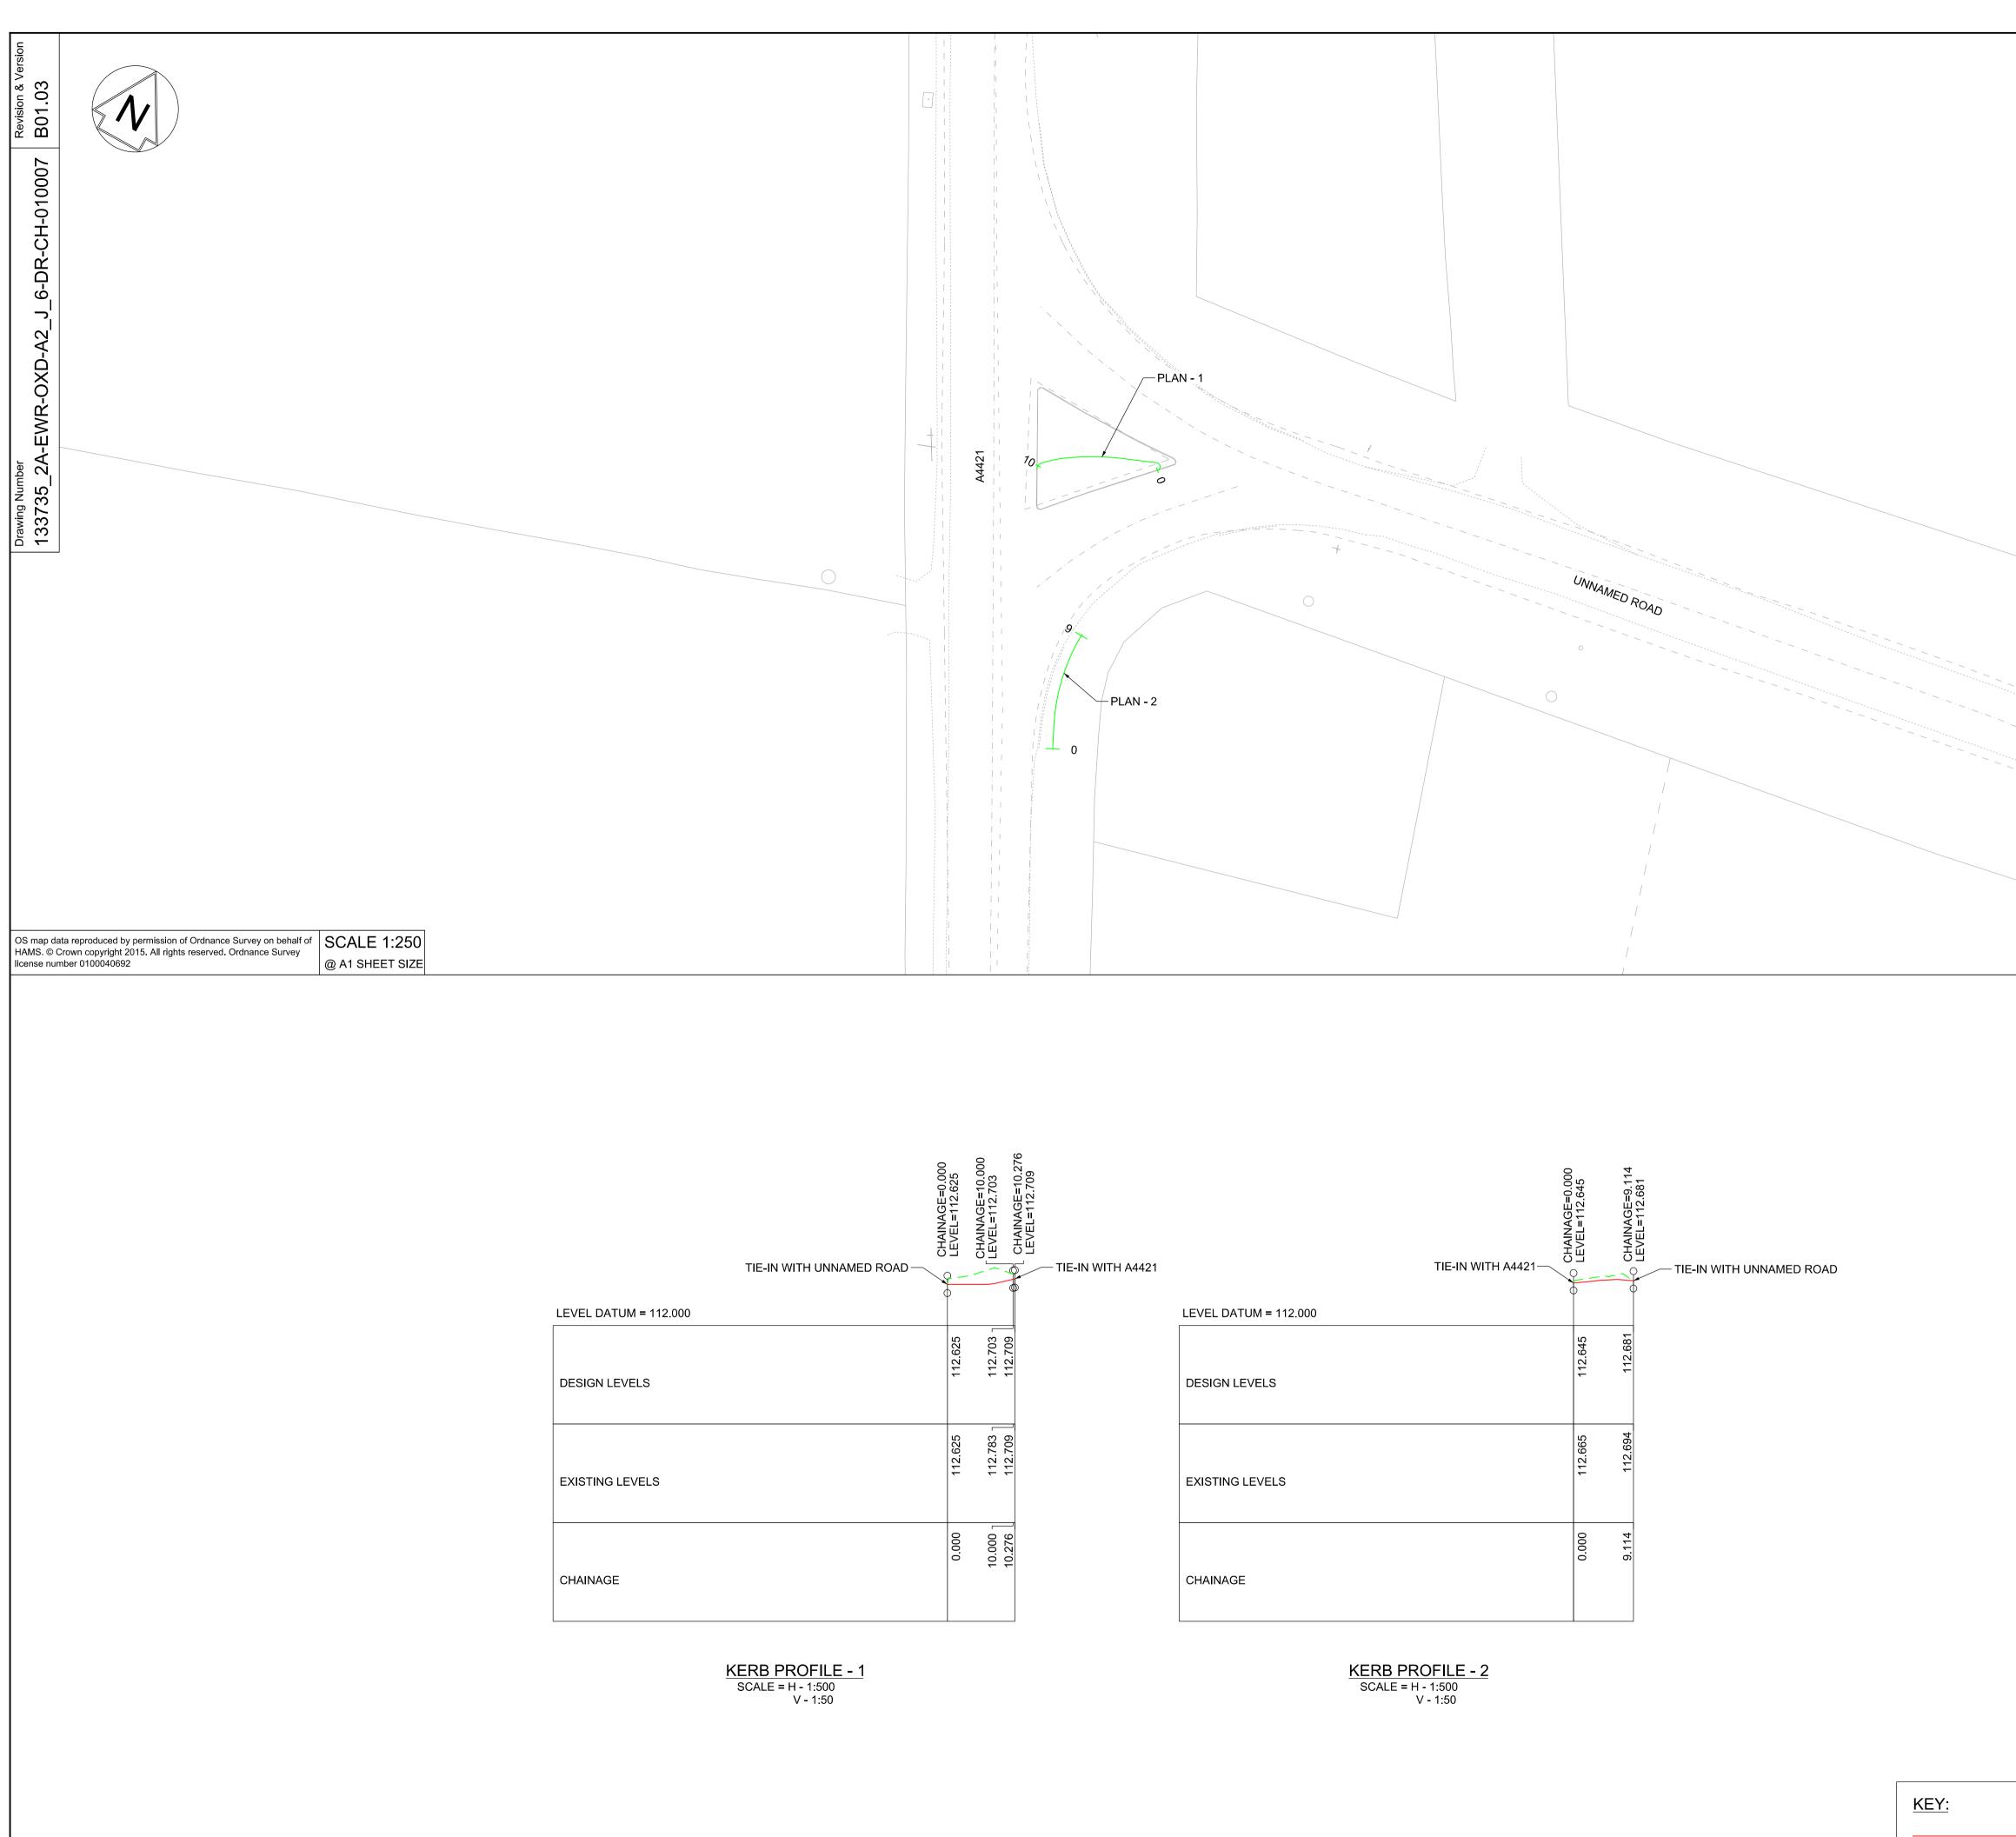
Designed	Nagoth Thom	nas Ravi Kuma	r <sup>Signed</sup> I	N. T. R. K	umar	<sup>Date</sup> 06/12/19
Drawn	Ravikumar K	N	Signed	R. KN	1	Date 26/03/19
Checked	Gareth Johns	ton	Signed	G. Johns	ston	<sup>Date</sup> 06/12/19
Approved	Stephen Abe		Signed	S. Abe	e	<sup>Date</sup> 09/12/19
<sup>Scale(s)</sup> 1:250	1	ELR - Project Cha OXD -	ainage (N	1iles Yards)		
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OS map data reproduced by permission of Ordnance Survey on behalf of HMSO. © Crown copyright 2015. All rights reserved. Ordnance Survey license number 0100040692	of SCALE 1:250 @ A1 SHEET SIZE	



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вт	<ul> <li>NETWORK RAIL (EAST WEST RAIL WESTERN SECTION PHASE 2).</li> <li>DOTES</li> <li>1 HIS DRAWING IS NOT TO BE SCALED.</li> <li>ALL DIMENSIONS ARE IN METRES (m) UNLESS SHOWN OTHERWISE.</li> <li>THIS DRAWING IS TO BE READ IN CONJUNCTION WITH THE HIGHWAY DESIGN PACKAGE OF DRAWINGS AND DOCUMENTS.</li> <li>THE EXACT LOCATION AND EXTENT OF BURIED SERVICES SHALL BE VERIFIED ON SITE PRIOR TO COMMENCEMENT OF THE WORKS. AGREEMENT WITH PRIVATE LAND OWNERS SHALL BE OBTAINED PRIOR TO WORKS WHERE ACCESS TO PRIVATE LAND IS REQUIRED.</li> <li>THIS DRAWING SHOWS THE POSITION OF UTILITY COMPANIES APPARATUS KNOWN TO OPERATE IN THE AREA IMMEDIATELY ADJACENT TO AND WITHIN THE LAND TAKE BOUNDARY FOR EAST WEST RAIL.</li> <li>THE POSITIONS INDICATED FOR THE APPARATUS ARE BASED ON RECORDS PROVIDED BY NETWORK RAIL THE ACCURACY OF THE RECORDS MAINTAINED BY THE UTILITY COMPANIES, THE METHODS AVAILABLE TO PROCESS / REPRODUCE THIS INFORMATION IN THE DRAWINGS AND THE AGE OF THE INFORMATION IN THE DRAWINGS AND THE AGE OF THE INFORMATION. IN THE DRAWINGS AND THE AGE OF THE INFORMATION IN THE DRAWINGS AND THE AGE OF THE INFORMATION IN THE DRAWINGS AND THE AGE OF THE INFORMATION. THERE IS THE POSSIBILITY THAT APPARATUS HAS BEEN ADDED OR REMOVED SINCE THE RECORDS WERE PROVIDED.</li> <li>ALL SEARCHES MUST BE VERIFIED AND ESTABLISHED ON SITE BEFORE WORK COMMENCES. IT IS THE RESPONSIBILITY OF THE EWR ALLIANCE TO IDENTIFY AND LOCATE UTILITY PLANT PRIOR TO WORK GOING AHEAD.</li> </ul>
WATER	Image: Non-Status       Suitability
	SHARED - for Information S2 EWR Alliance Connecting People
	Project
	East West Rail (Western Section) Phase 2
	JUNCTION IMPROVEMENT A2_J_6
HIGHWAY BOUNDARY	EXISTING UTILITIES
	Designed     Nagoth Thomas Ravi Kumar     Signed     N. T. R. Kumar     Date     06/12/19       Drawn     Bavikumar KN     Signed     B. KN     Date     26/02/10
GRASS VERGE	DrawnRavikumar KNSignedR. KNDate26/03/19CheckedGareth JohnstonSignedG. JohnstonDate06/12/19
PROPOSED EARTHWORKS	Approved         Stephen Abe         Signed         S. Abe         Date 09/12/19
BULL NOSED KERB (FULL HEIGHT)	Scale(s)     ELR - Project Chainage (Miles Yards)       1:250     OXD -       Design Package Risk Classification     Sheet
	Alternative Reference Revision
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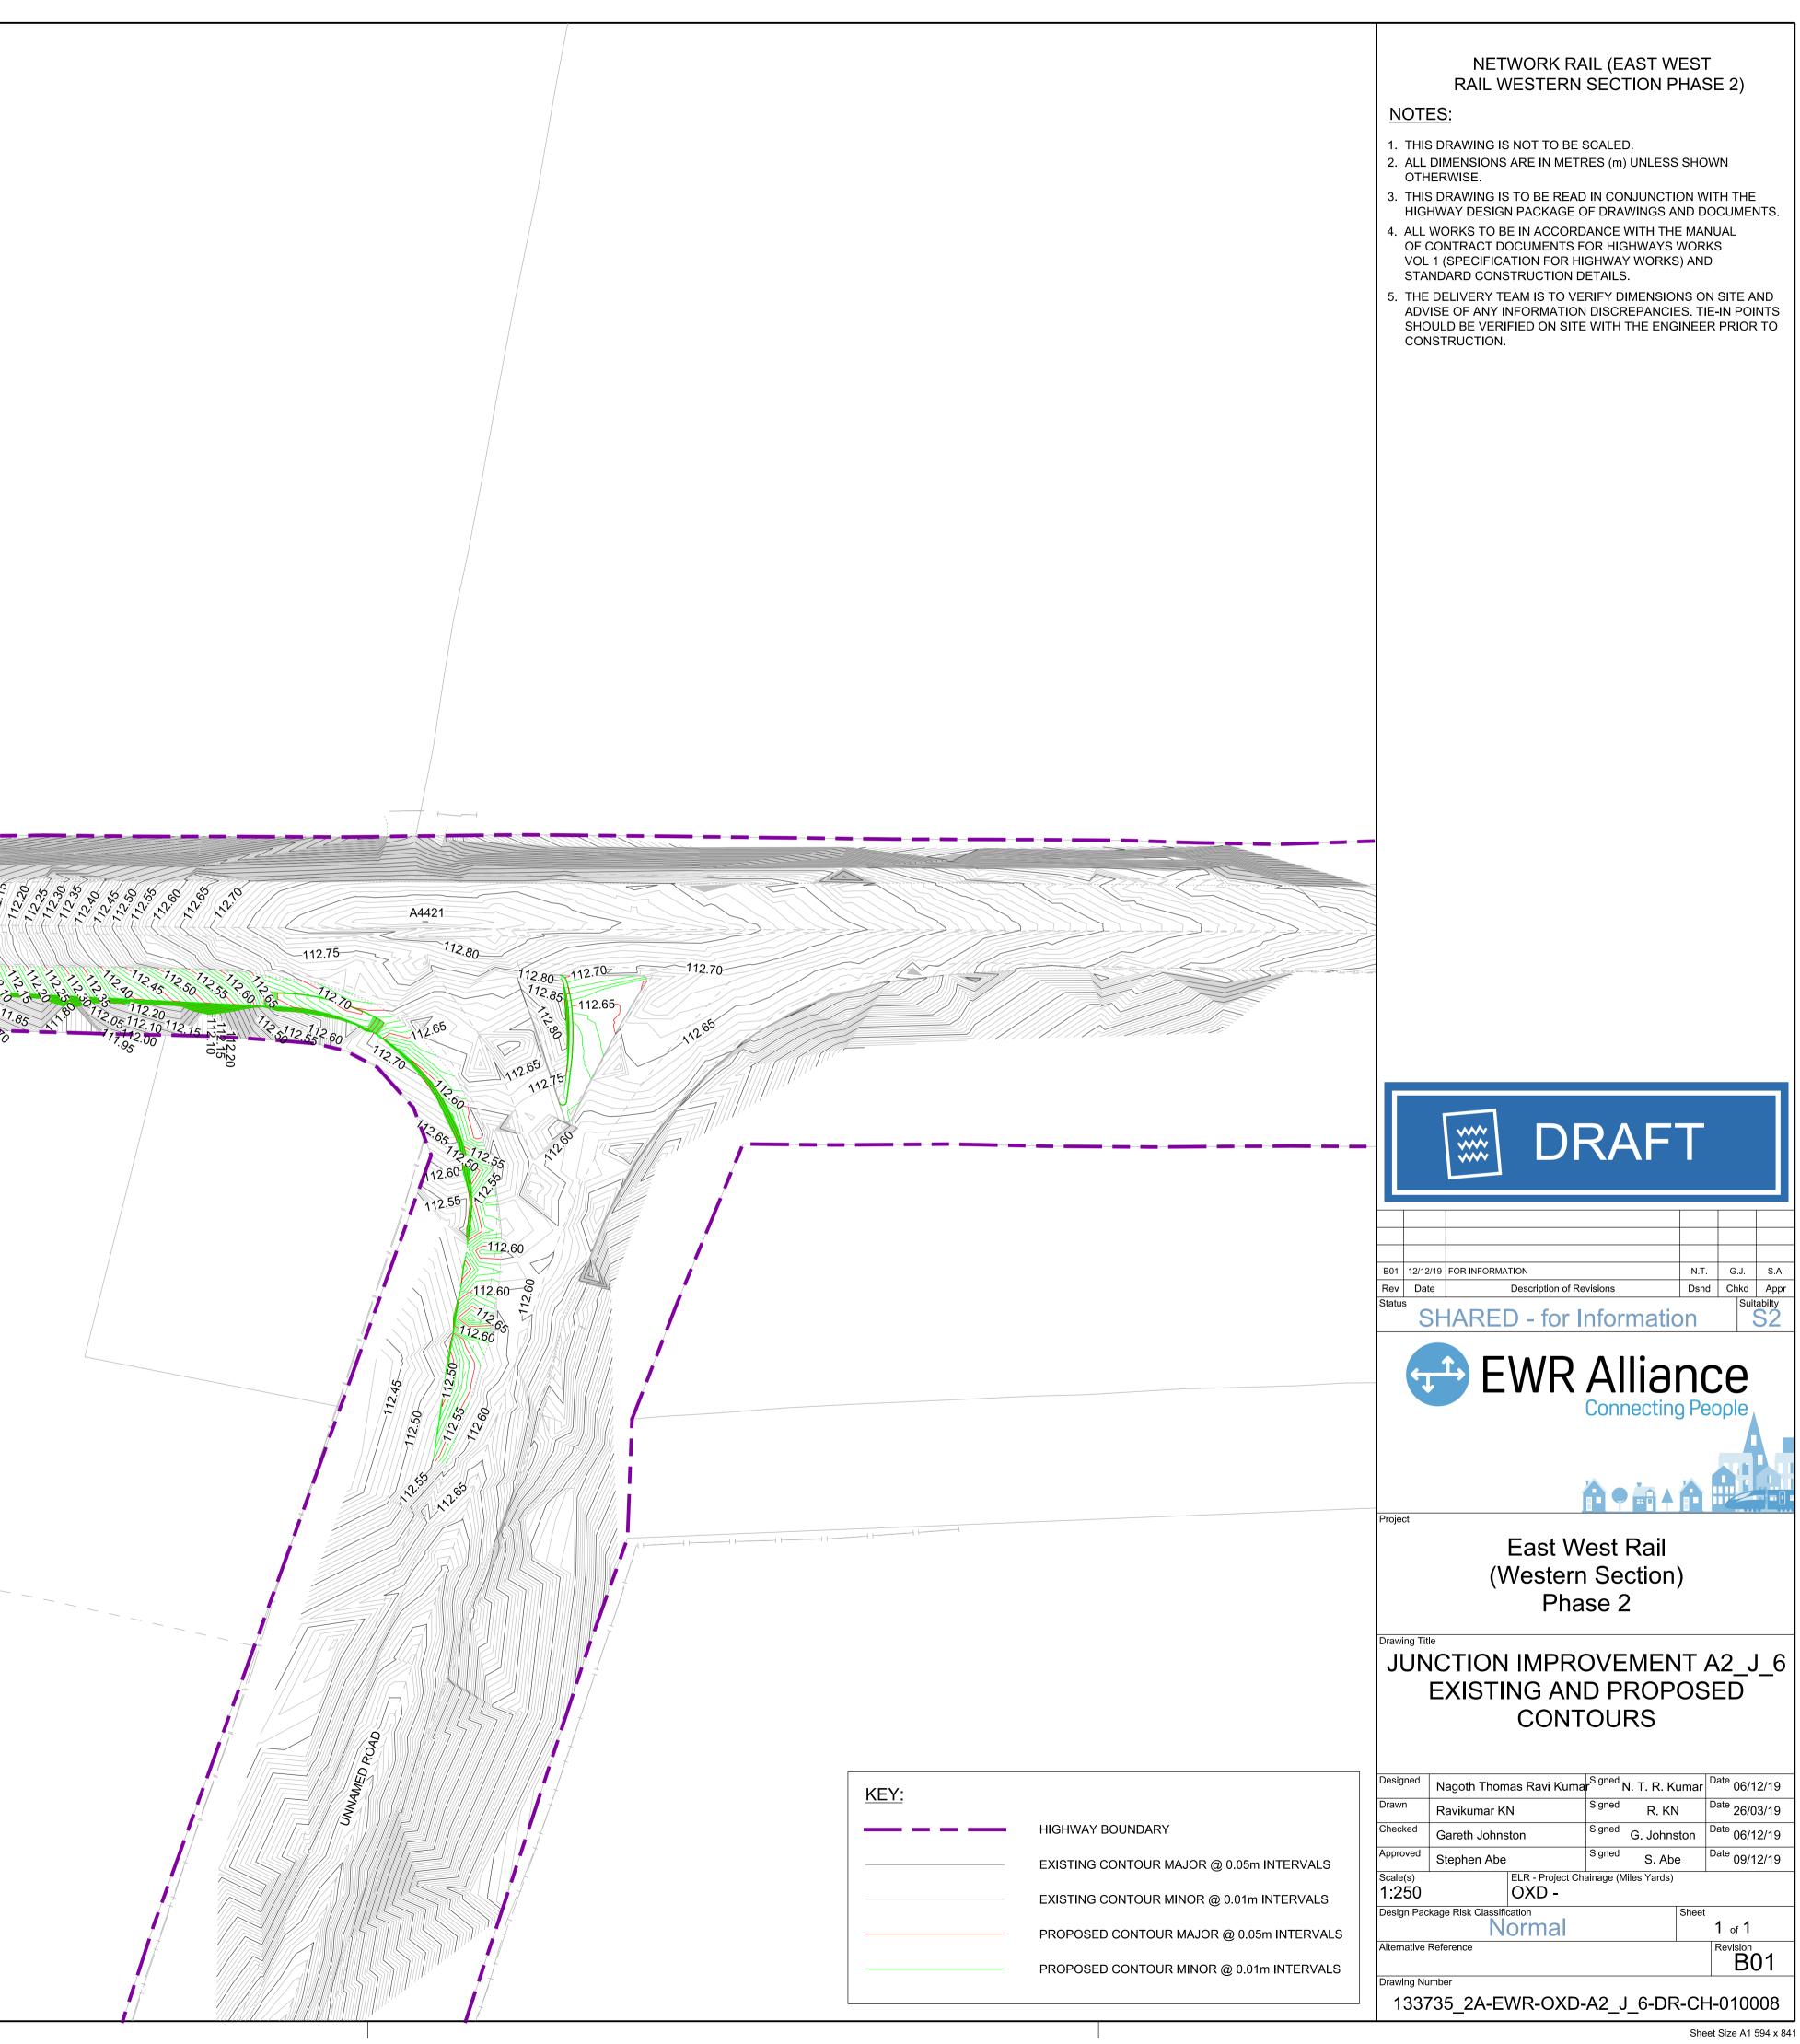


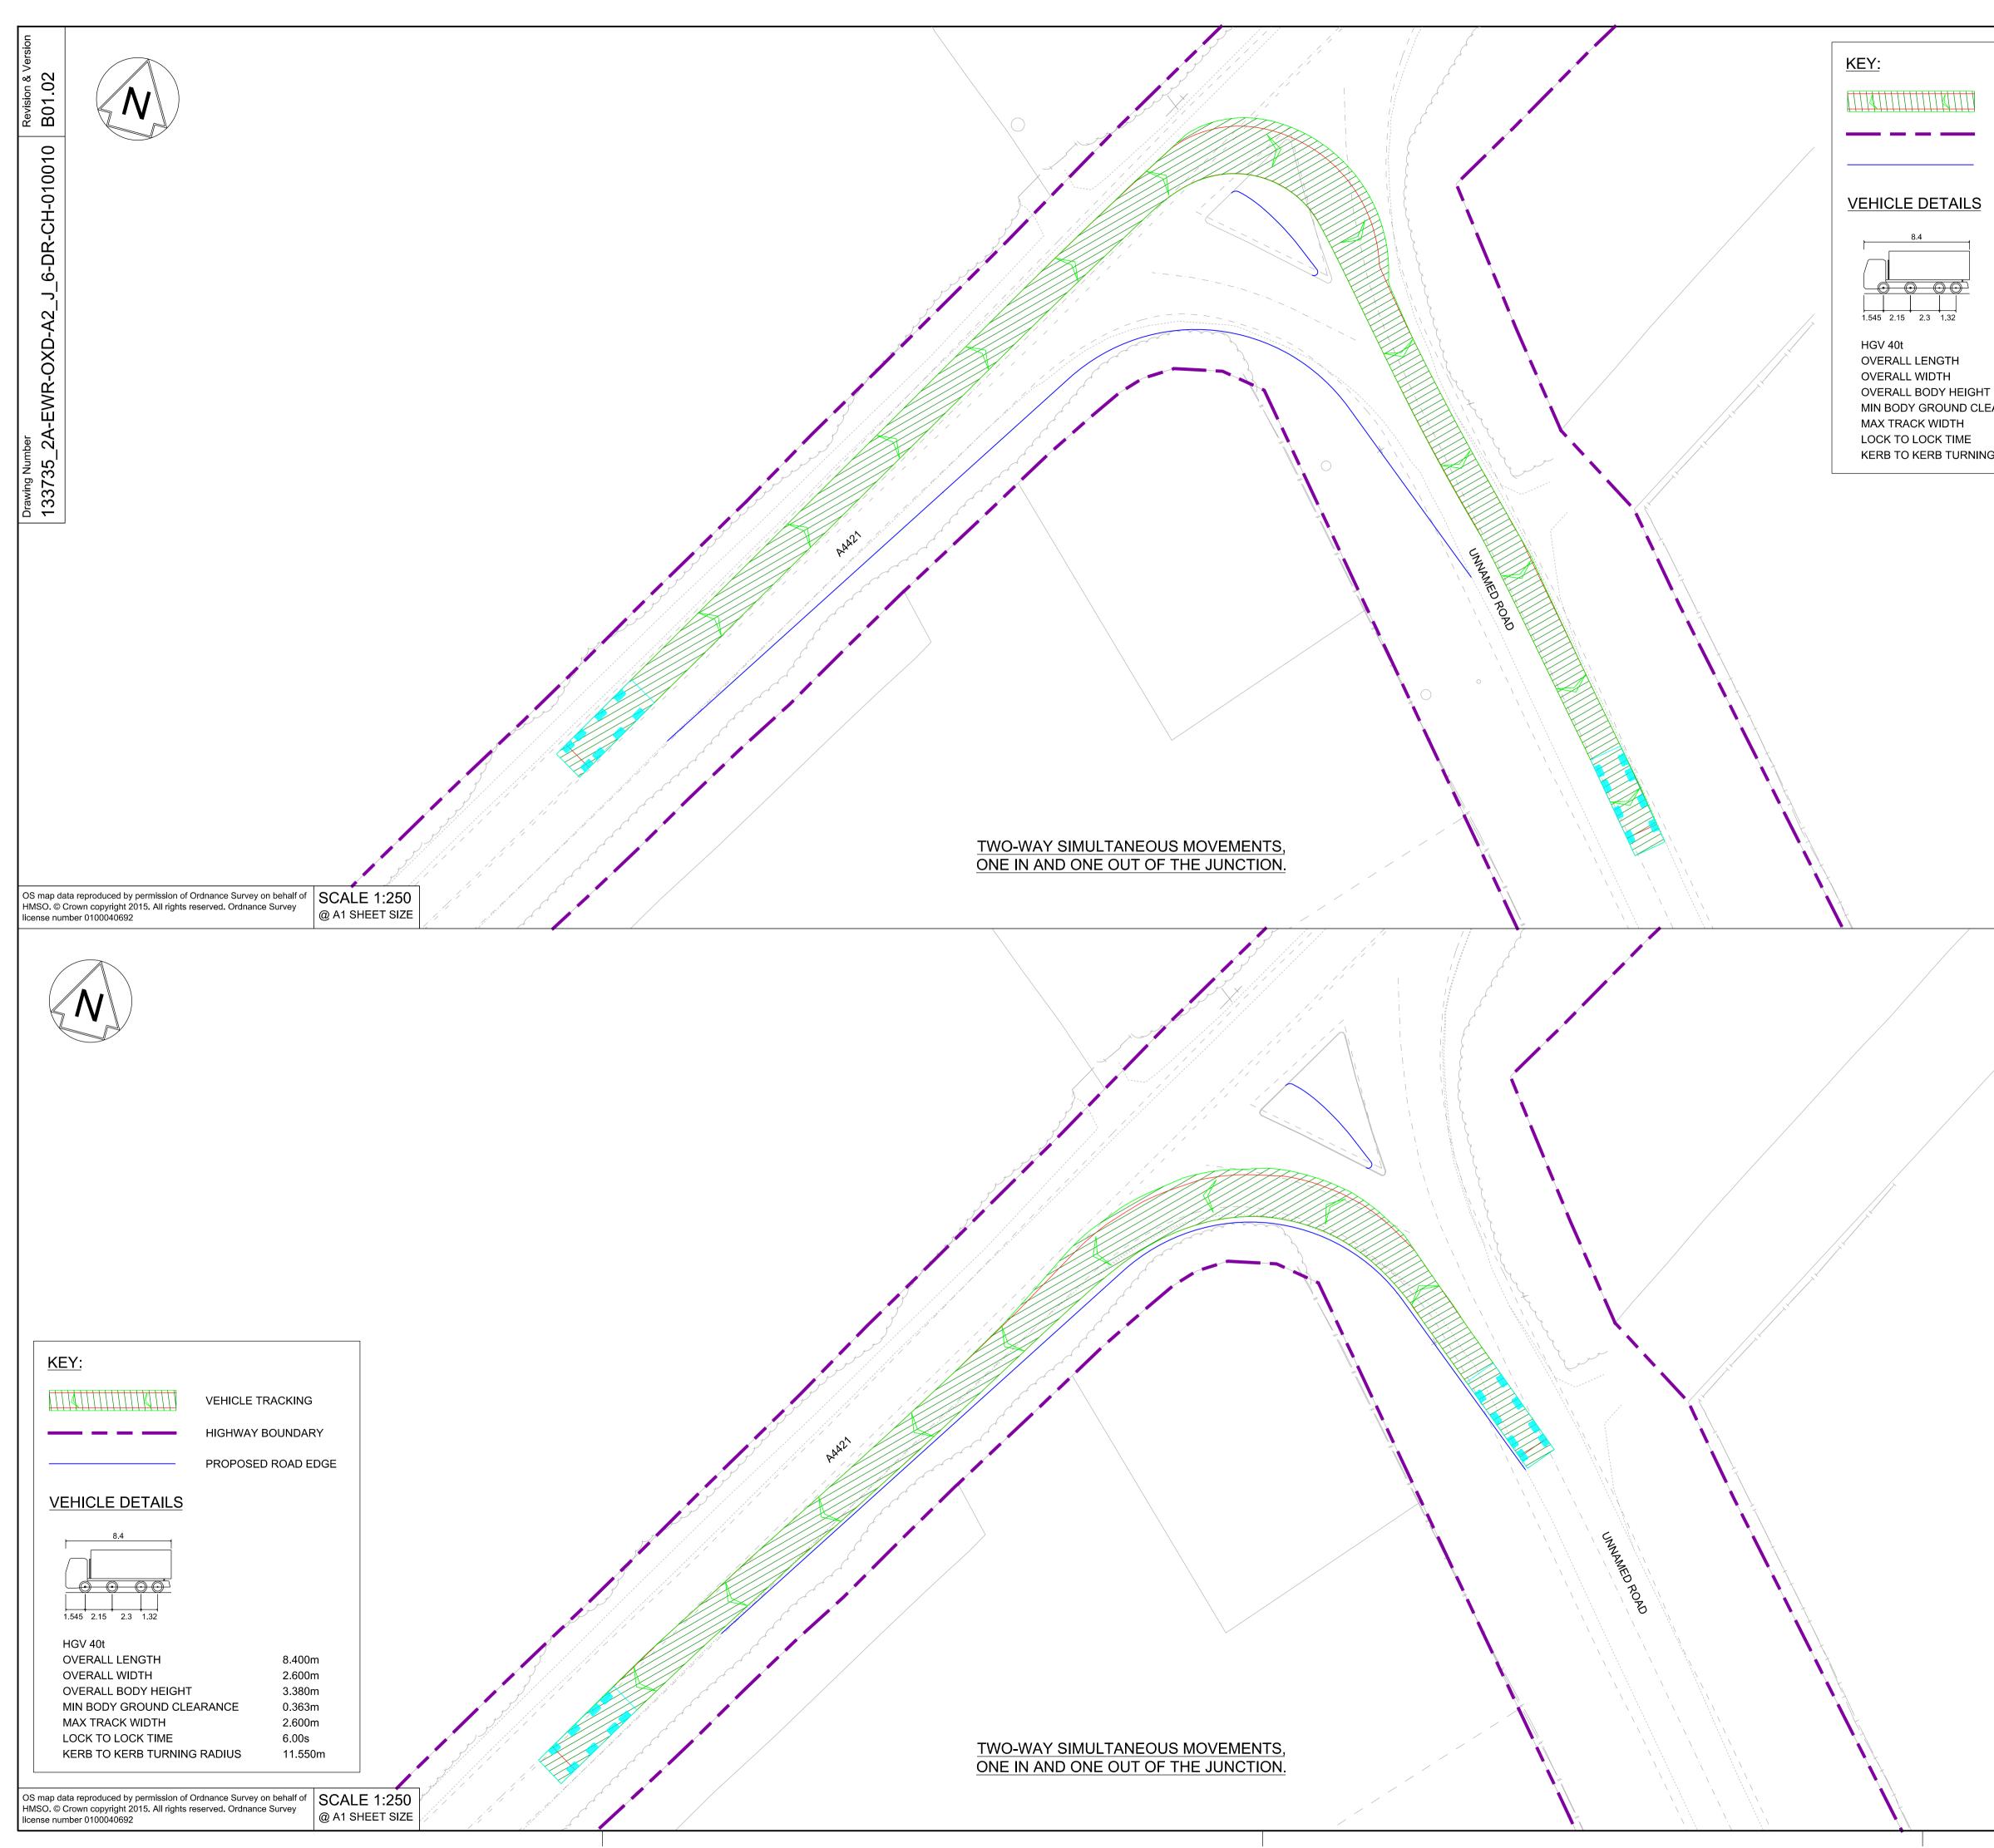
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	RAIL WESTERN SECTION PHASE 2)
	NOTES:
	1. THIS DRAWING IS NOT TO BE SCALED.
	2. ALL DIMENSIONS ARE IN METRES (m) UNLESS SHOWN OTHERWISE.
	3. THIS DRAWING IS TO BE READ IN CONJUNCTION WITH THE HIGHWAY DESIGN PACKAGE OF DRAWINGS AND DOCUMENTS.
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	EWR Alliance
	Connecting People
	Project
	East West Rail
	(Western Section)
	Phase 2
	Drawing Title
	JUNCTION IMPROVEMENT A2_J_6
	KERB PLAN AND PROFILE
	Designed Nagoth Thomas Ravi Kumar <sup>Signed</sup> N. T. R. Kumar <sup>Date</sup> 06/12/19
	Drawn     Ravikumar KN     Signed     R. KN     Date     26/03/19
	CheckedGareth JohnstonSignedG. JohnstonDate06/12/19
	Approved         Stephen Abe         Signed         S. Abe         Date         09/12/19
KEV	Scale(s)       ELR - Project Chainage (Miles Yards)         AS SHOWN       OXD -
KEY:	Design Package Risk Classification Sheet
NEW ROAD EDGE LEVEL	Normal         1 of 1           Alternative Reference         Revision
EXISTING SURFACE LEVEL	Drawing Number
	133735_2A-EWR-OXD-A2_J_6-DR-CH-010007

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# VEHICLE TRACKING

HIGHWAY BOUNDARY

PROPOSED ROAD EDGE

8.400m

2.600m

3.380m

0.363m

2.600m

6.00s

11.550m

MIN BODY GROUND CLEARANCE KERB TO KERB TURNING RADIUS

### NETWORK RAIL (EAST WEST RAIL WESTERN SECTION PHASE 2)

NOTES:

. THIS DRAWING IS NOT TO BE SCALED.

- 2. ALL DIMENSIONS ARE IN METRES (m) UNLESS SHOWN OTHERWISE.
- 3. VEHICLE TRACKING IS UNDERTAKEN WITH COMPUTER MODELLING SOFTWARE AND IS BASED ON IDEAL SITUATIONS WHERE REAL WORLD OBSTRUCTIONS ON THE ROAD NETWORK SUCH AS PARKING OR LOADING ACTIVITY WOULD NOT HAVE BEEN FORESEEN.
- 4. THE MODELLING IS BASED IN 2D PLAN WHERE SWEPT PATHS ARE INFLUENCED BY ANTICIPATED MOVEMENTS AND THEREFORE LEAD TO IDEAL APPROACH ANGLES, WHICH MIGHT NOT BE OBVIOUS IN REALITY.
- 5. APPROACH SPEEDS, APPROACH ANGLES, ROAD SURFACE, WEATHER CONDITIONS AND TYRE WEAR ARE ALL FACTORS THAT WILL INFLUENCE VEHICLE PATHS.
- 6. JUNCTION HAVE BEEN DESIGNED FOR THE FOLLOWING VEHICLES AND MOVEMENTS:
- A) SIMULTANEOUS TWO-WAY ONE IN AND ONE OUT MOVEMENT FOR A 40T HGV.
- B) ONE IN AND ONE OUT SINGLE DIRECTION MOVEMENT FOR A LOW LOADER.
- C) ONE IN AND ONE OUT SINGLE DIRECTION MOVEMENT FOR A MAX LEGAL (16.5m) ARTICULATED HGV.

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VEHICLE TRACKING

# HIGHWAY BOUNDARY

PROPOSED ROAD EDGE

1	16.500m	
	2.550m	
EIGHT	3.681m	
ID CLEARANCE	0.411m	
н	2.500m	
ME	6.00s	
JRNING RADIUS	6.530m	

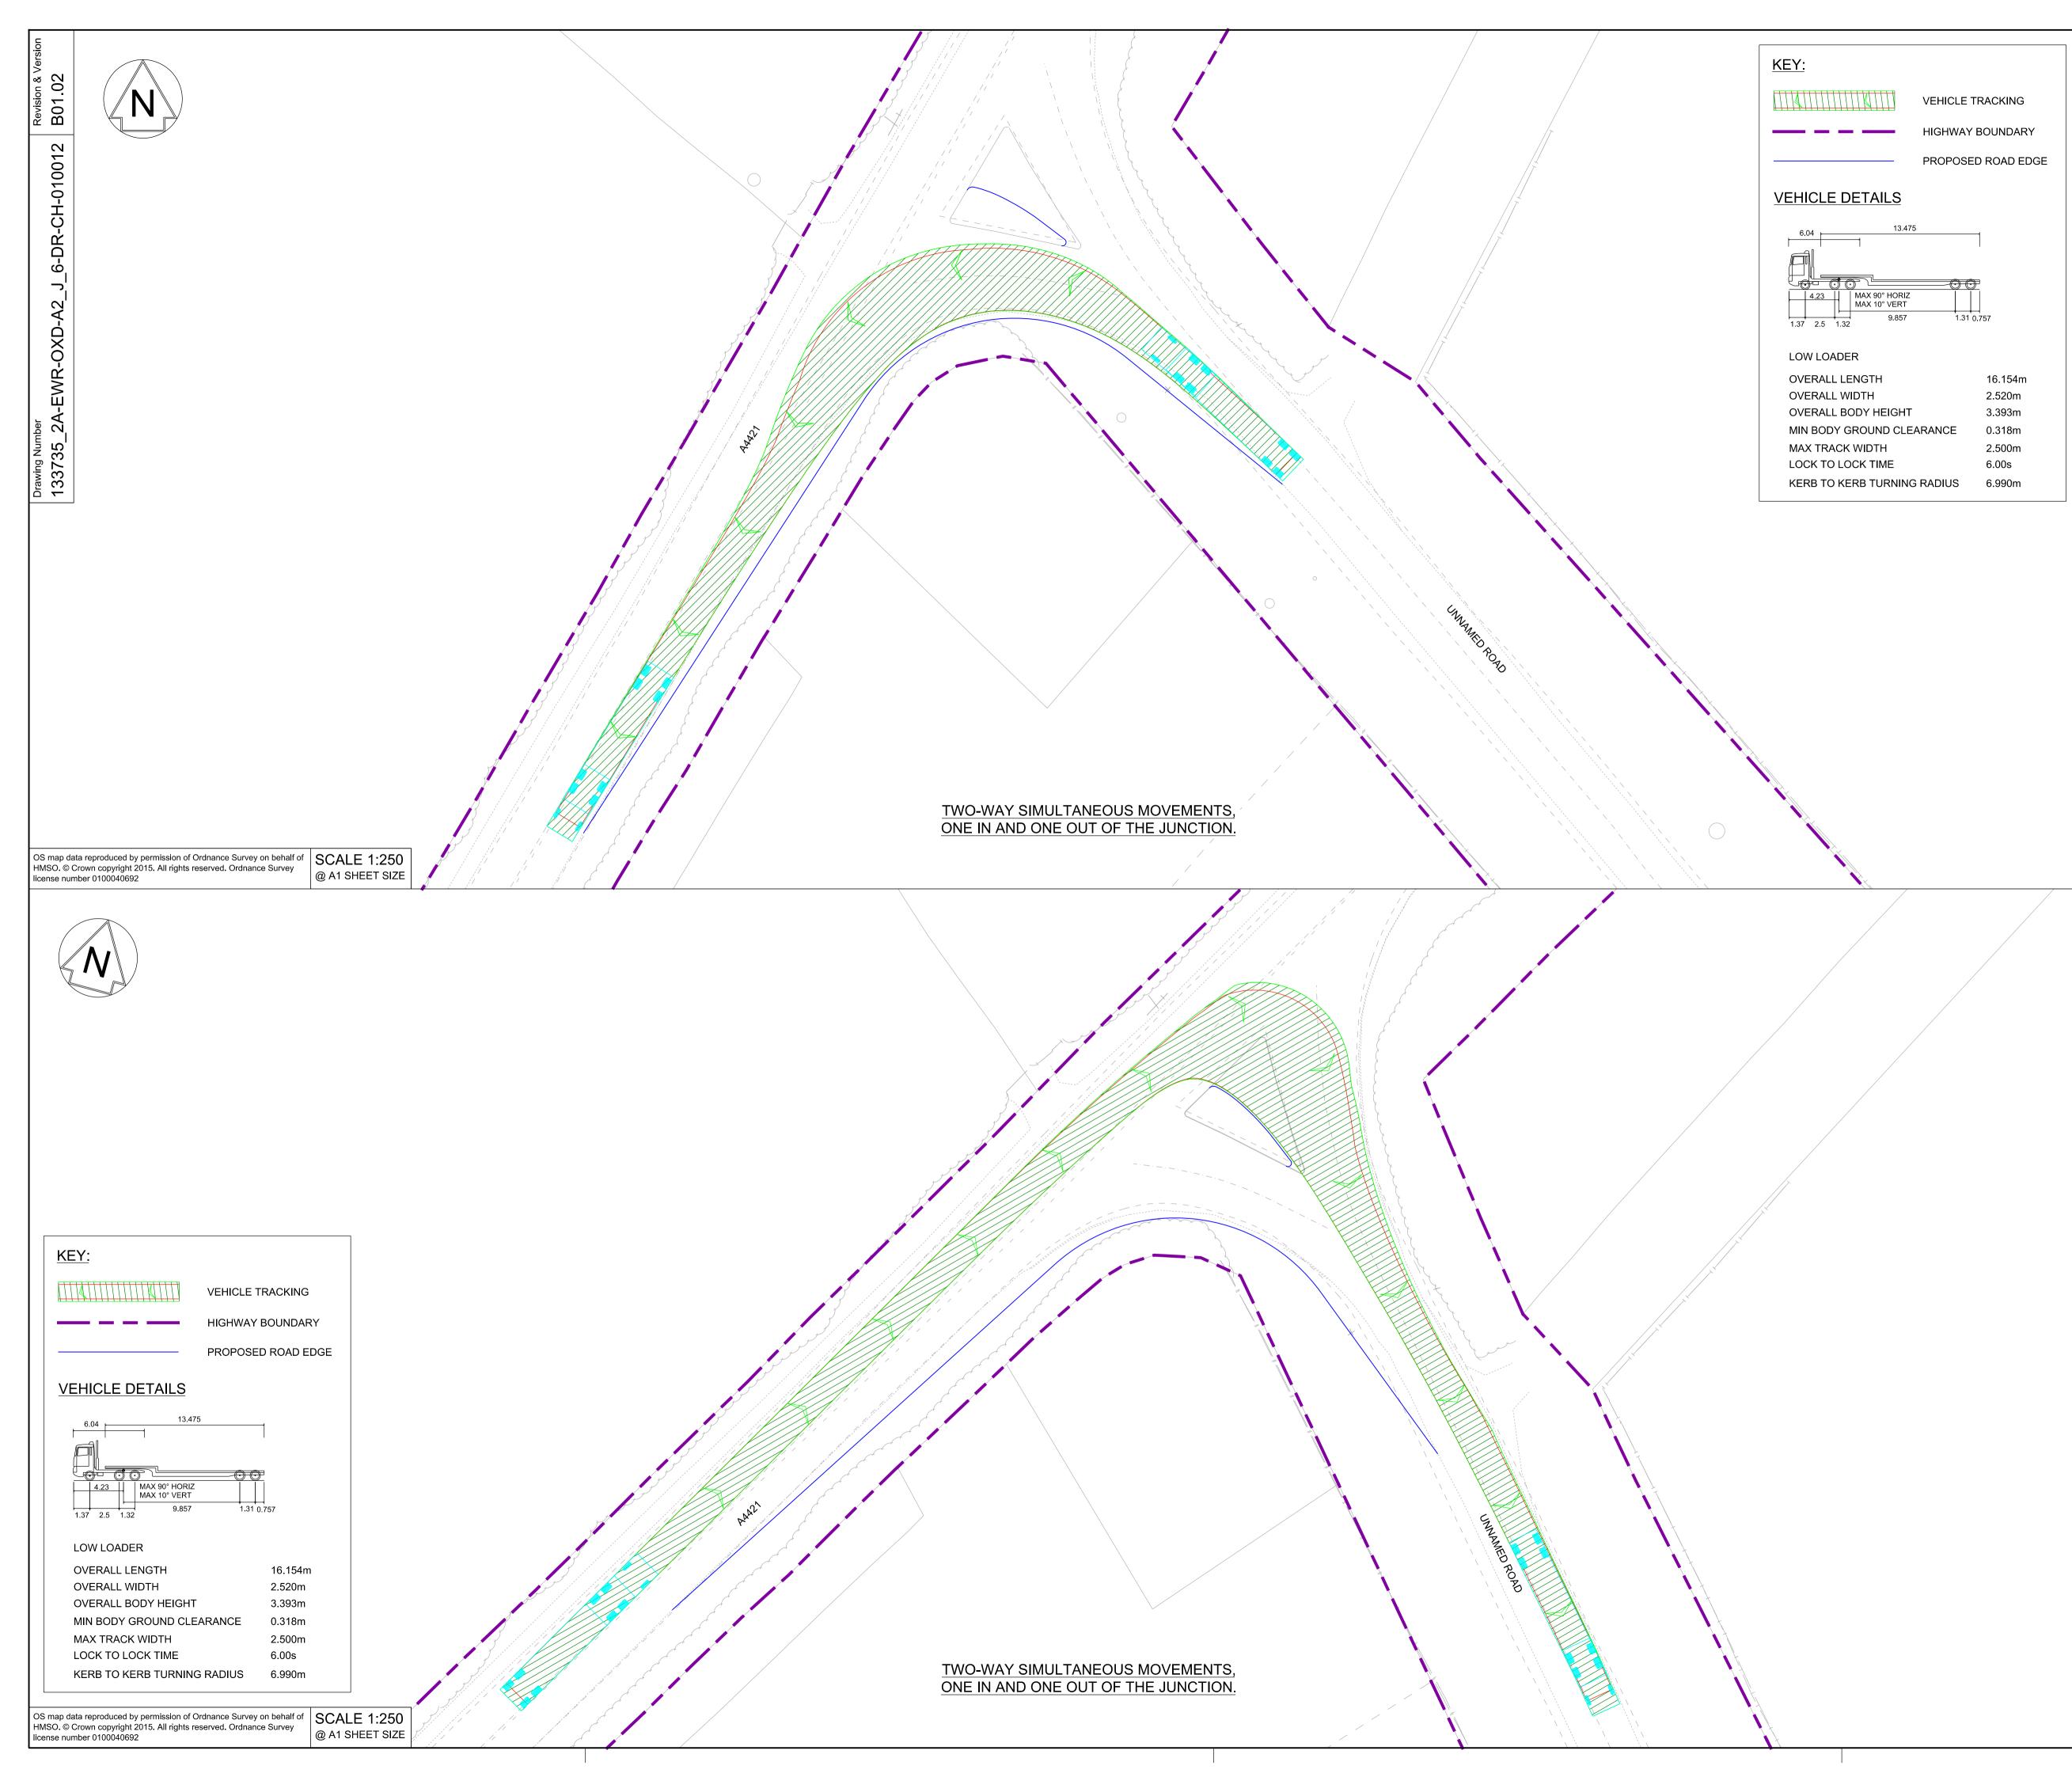
## NETWORK RAIL (EAST WEST RAIL WESTERN SECTION PHASE 2)

NOTES:

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Project	(Western	est Rail Section) se 2	)	
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Designed	Nagoth Thomas Ravi Kuma	Signed	ımar <sup>Date</sup> 06/1	0/10
Drawn		Signed	Date 08/0	
Checked	Ravikumar KN	Signed	Dete	2/19
Approved	Gareth Johnston	G. Johnst Signed S. Abe		2/19
Scale(s) 1:250	Stephen Abe ELR - Project Cha OXD -	ainage (Miles Yards)	09/1	2/19
Design Pac	kage Risk Classification		Sheet 2 of 3	
Alternative	Reference		Revision	)1
Drawing Nu	<sup>ımber</sup> 735_2A-EWR-OXD-	A2_J_6-DR		-
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## NETWORK RAIL (EAST WEST RAIL WESTERN SECTION PHASE 2)

NOTES:

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- 2. ALL DIMENSIONS ARE IN METRES (m) UNLESS SHOWN OTHERWISE.
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Irawn	Nagoth Thomas Ravi Kuma Ravikumar KN	Signed R. KN		Date 08/08/19
Drawn Checked		Signed R. KN Signed G. Johns		Date 08/08/19
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