




OUTFALL INTO THE EXISTING HIGHWAY DRAINAGE DITCH FROM NETWORK 2_A1.2
PLAN
SCALE: 1:100

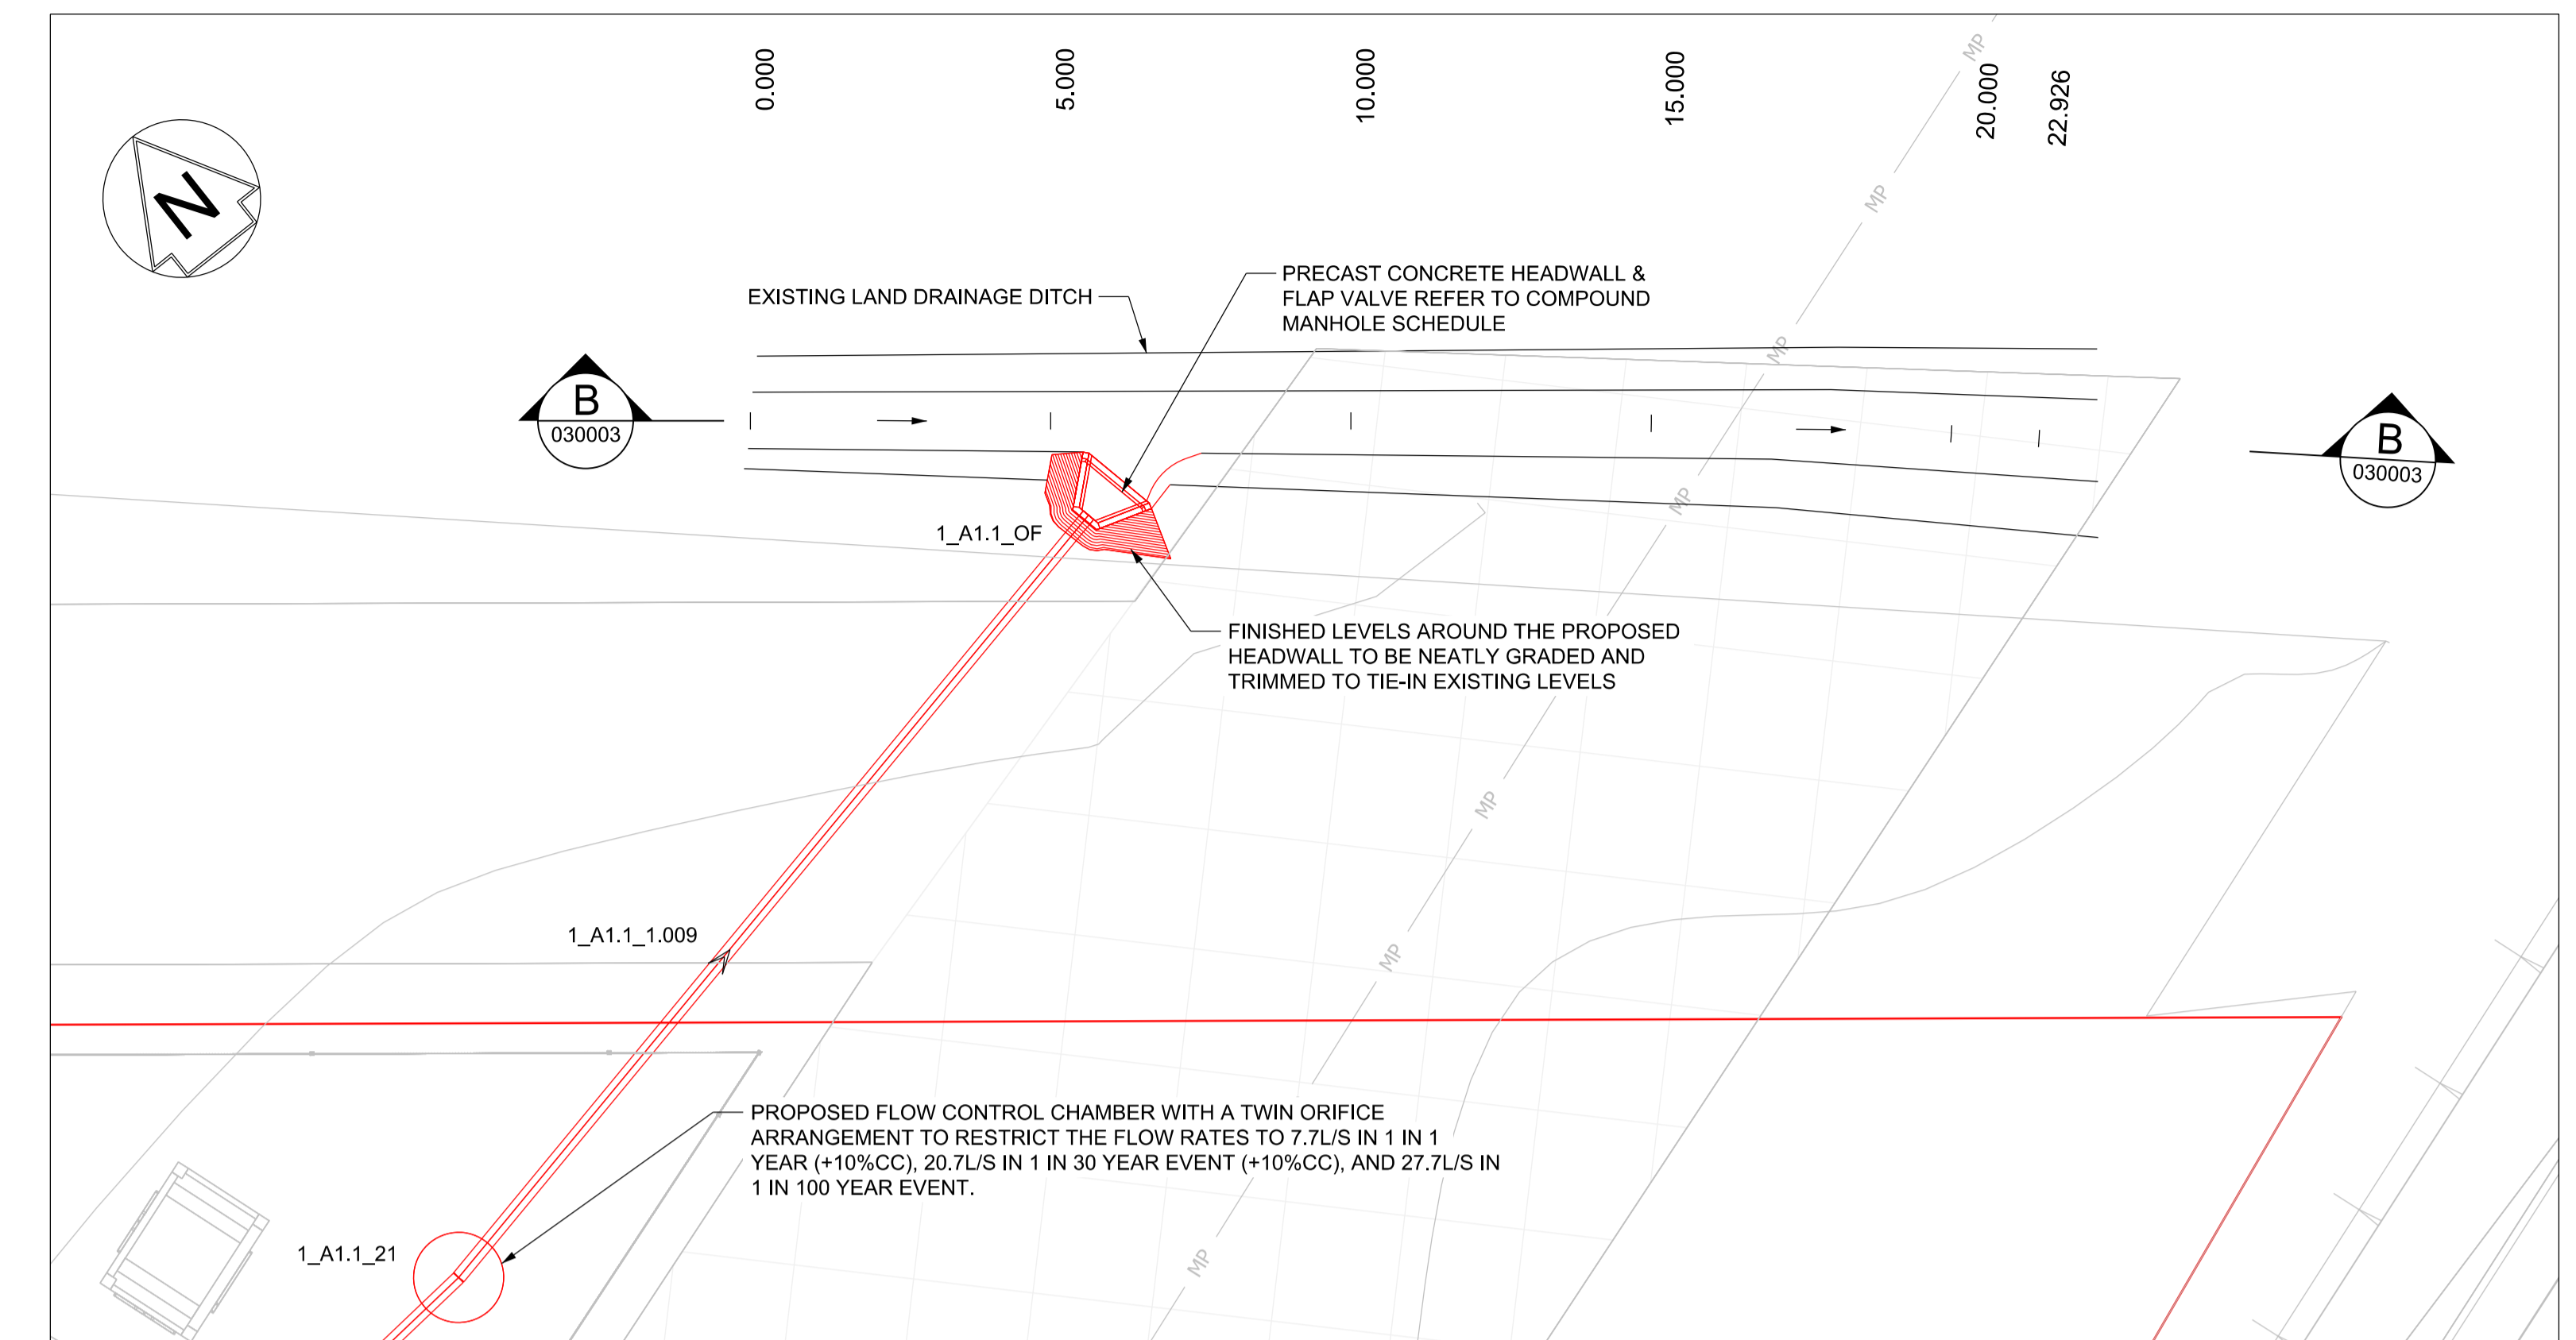

OUTFALL INTO THE EXISTING LAND DRAINAGE DITCH FROM NETWORK 1_A1.1
PLAN
SCALE: 1:100

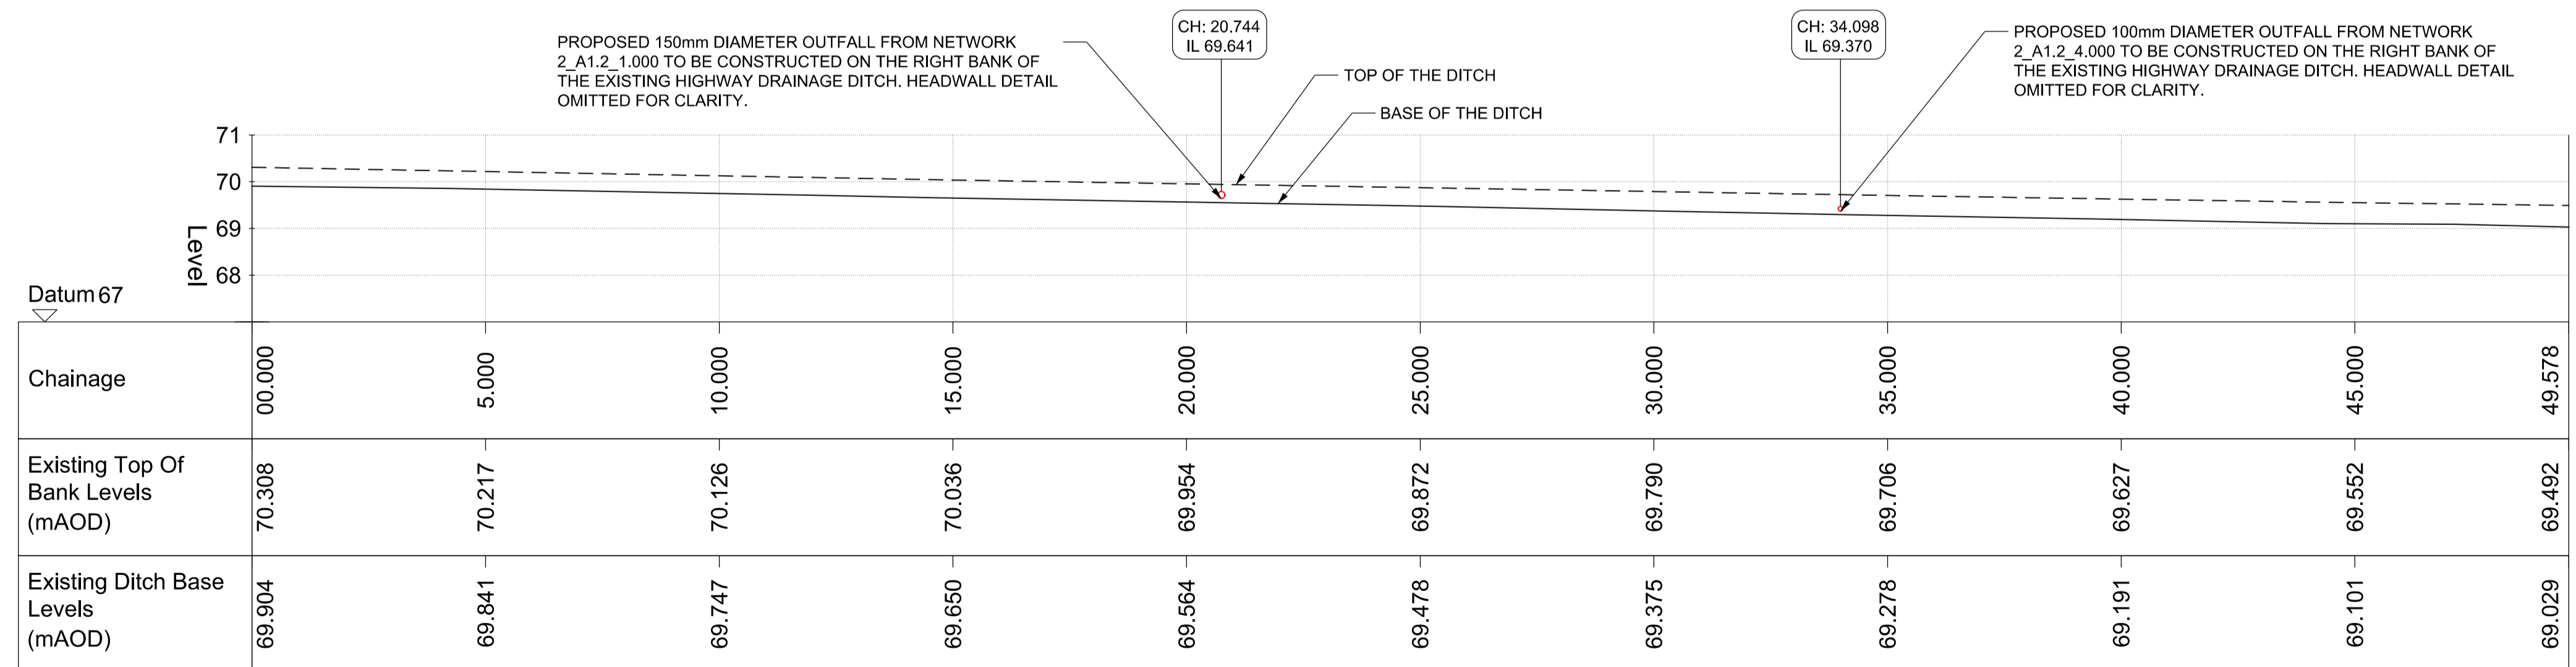

EXISTING HIGHWAY DRAINAGE DITCH - LONGITUDINAL SECTION A-A
SCALE: H 1:100, V 1:100.

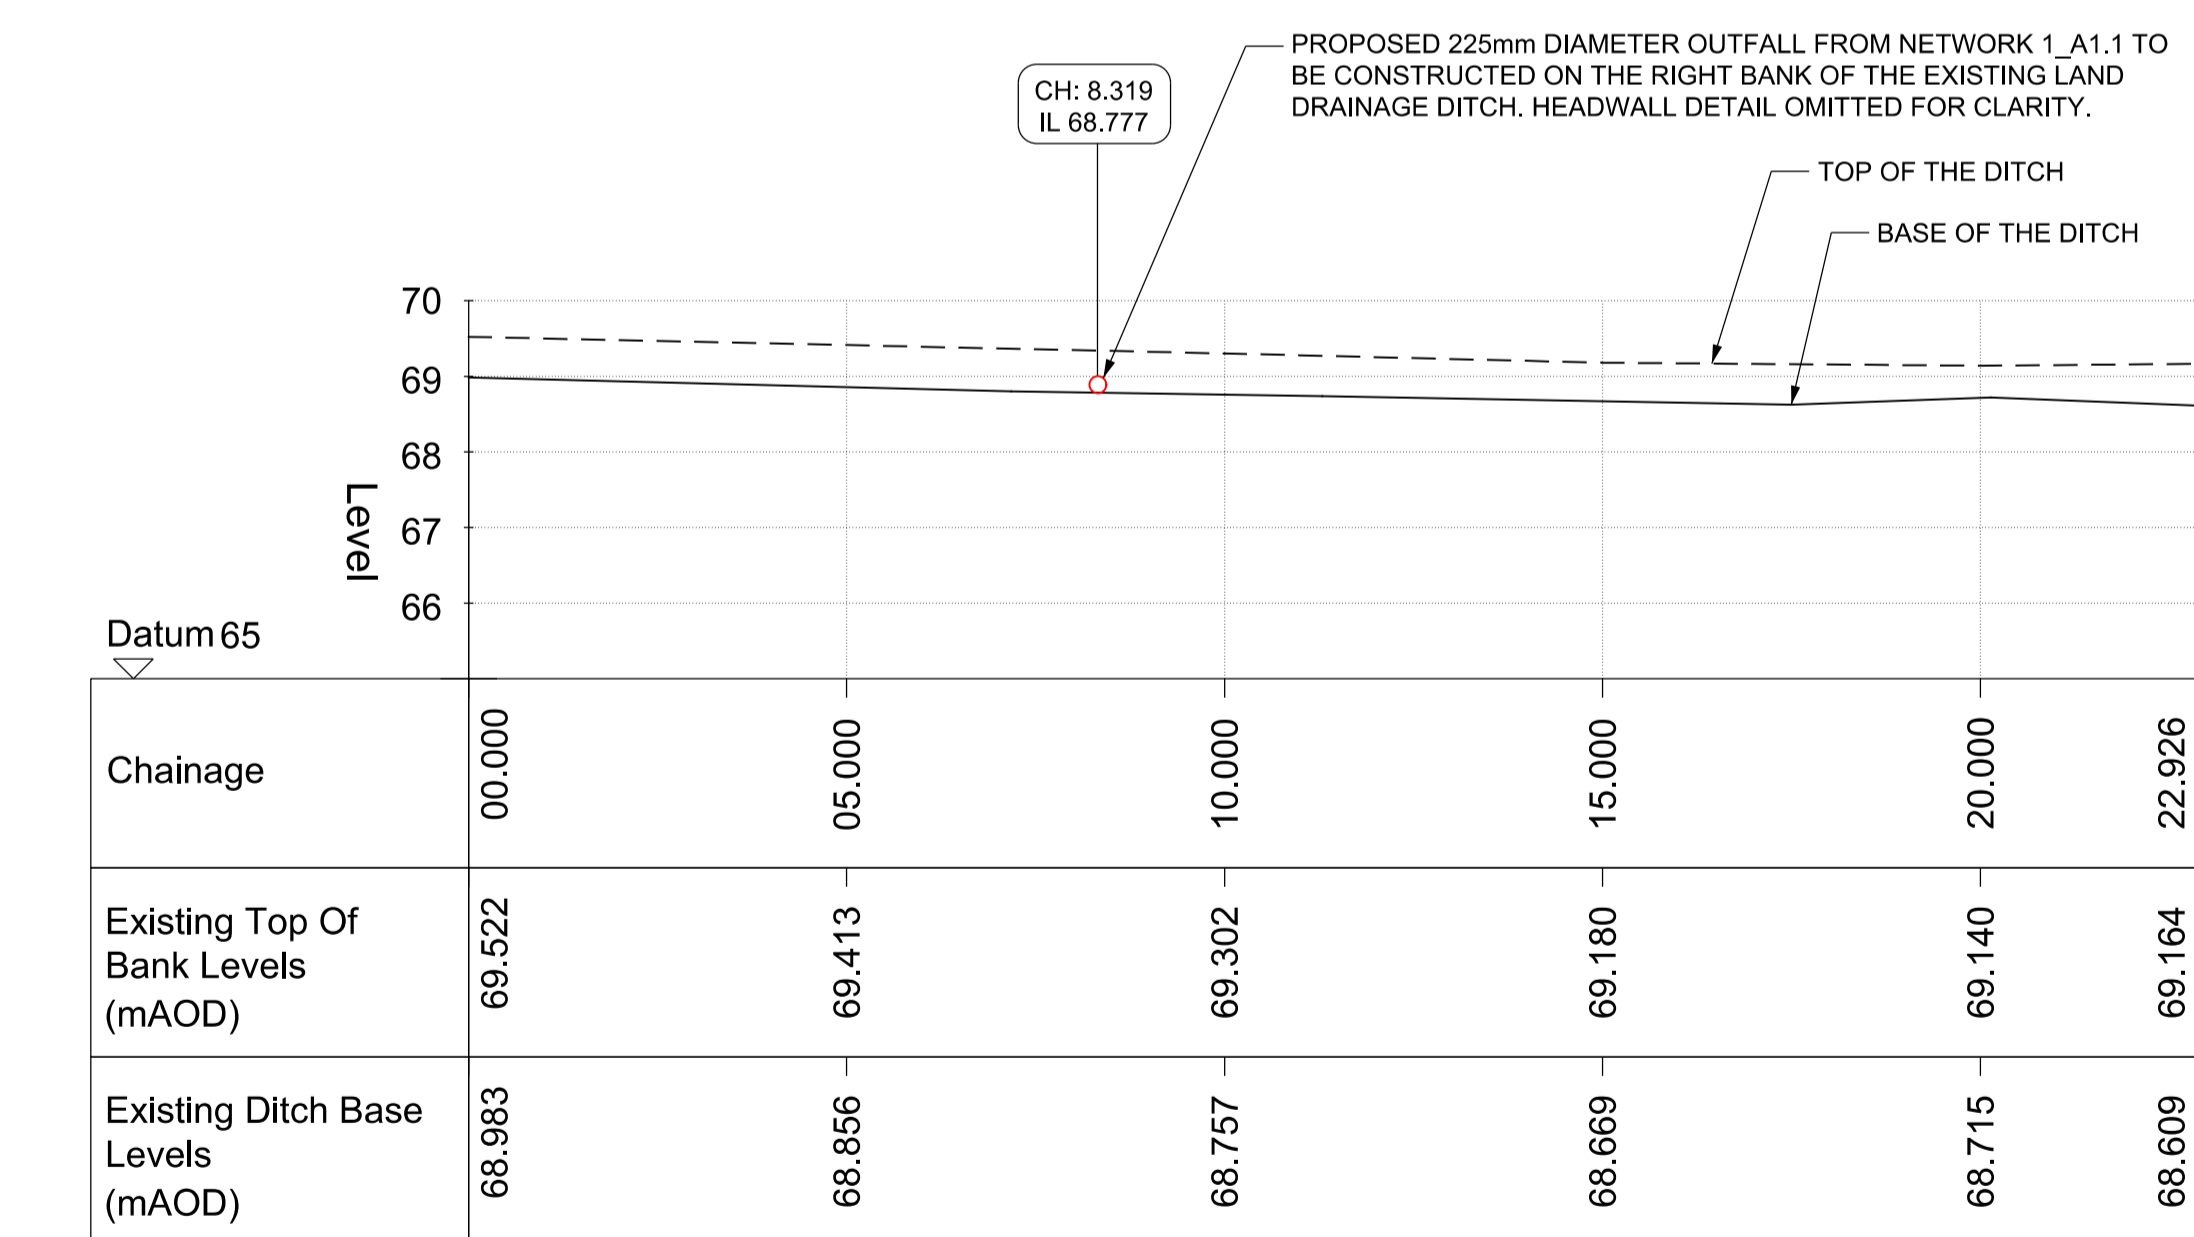

EXISTING LAND DRAINAGE DITCH - LONGITUDINAL SECTION B-B
SCALE: H 1:100, V 1:100.

- NOTES
- THIS DRAWING IS NOT TO BE SCALED. ALL DIMENSIONS ARE IN METRES UNLESS OTHERWISE STATED. ALL LEVELS ARE IN mAOD. ALL COORDINATES ARE BASED ON EWR2 SNAKEGRID.
 - THIS DRAWING SHOULD BE READ IN CONJUNCTION WITH CROSS SECTION DRAWING 133735_RW-EWR-XX-XX-DR-DH-030002 AND 030003
 - DRAINAGE SHALL BE CONSTRUCTED IN ACCORDANCE WITH SPECIFICATION 133735_RW-EWR-XX-XX-SP-DR-000001.
 - EXISTING LEVELS ARE BASED ON TOPOGRAPHICAL SURVEY DATA UNLESS STATED OTHERWISE (ADD MODEL REFERENCE NO FOR TOPO SURVEY) 133735_RW-EWR-XX-XX-A3-G-000049.

- KEY:
- COMPOUND BOUNDARY
 - EXISTING WATERCOURSE
 - EXISTING LOW VOLTAGE ELECTRICITY CABLE (UNDERGROUND)
 - EXISTING MEDIUM PRESSURE GAS MAIN
 - EXISTING HIGH PRESSURE GAS MAIN
 - EXISTING HIGH VOLTAGE ELECTRICITY CABLE (UNDERGROUND)
 - PROPOSED CARRIER DRAIN
 - PROPOSED HEADWALL
 - PROPOSED DITCH (1 IN 1 SLOPE)
 - CATCHPIT / MANHOLE
 - PROPOSED HAYBALES INSIDE THE ATTENUATION BASIN
 - BASE OF THE DITCH
 - TOP OF THE DITCH

Rev	Date	Description of Revisions	Drawn	Chkd	Appr	Status
B01	10/06/20	For Information				R.S. M.S. A.R.

SHARED - for Information

EWR Alliance
Connecting People

Project
East West Rail (Western Section) Phase 2

Drawing Title
CIVIL ENGINEERING DRAINAGE TEMPORARY COMPOUND A1 EXISTING HIGHWAY & LAND DRAINAGE PLAN & LONG SECTION

Drawn	Checked	Approved	Signed	Date
Faris Ibrahim	Mark Stevens	Adrian Rose	R. Sastry	10/06/20
			F. Ibrahim	07/11/19
			M. Stevens	10/06/20
			A. Rose	10/06/20

Scales:	1:100	ELR - Project Chainage (Miles Yards)	XX - OXD
Design Package Risk Classification	Normal		Sheet 1 of 5
Alternative Reference			Revision B01

